



CITY OF DE PERE NUG 2 A PAIR

## APPLICATION FOR SITE PLAN REVIEW

Fee:

\$ 350.00

Receipt #:

185441

Date: 8-24-23

Read all instructions provided before completing. If additional space is needed, attach additional pages. Type or use black ink. **SECTION 1: Applicant / Permittee Information** Applicant Name (Ind., Org. or Entity) Authorized Representative Title ONE SOURCE CONSTRUCTION OF BRATTON VICE PRESIDENT DAVID GEHRT ZIP Code State 3065 N. 124TH STREET, SUITE 202 BROOKFIELD WI 53005 **Email Address** Phone Number (incl. area code) Fax Number (incl. area code) davege oscainc, com 262,784,1010 SECTION 2: Landowner Information (complete these fields when project site owner is different than applicant) Name (Ind. Org. or Entity) Contact Person Title CHIEF FINANCIAL OFFICER WOLTER INVESTMENT COMPLNY LLD. STEVEN KLETZIEN Mailing Address ZIP Code State 3125 INTERTECH BROOKFIELD DRIVE 53045 **Email Address** Phone Number (incl. area code) Fax Number (incl. area code) steve. Kletziene Wolfering. COM 262. 781. 8011 Ext. 3110 **SECTION 3: Project or Site Location** Project Address/Description 374,421 SF (B.GMES) Parcel No. LICEW, MATTHEW DRIVE WD-364-D-505-8 **SECTION 4: Project Information** Existing Zoning: BP-1, BUSINESS PARK 1 Present Use of Parcel: VACANT LAND NEW 88,000 SF INDUSTRIAL WAREHOUSE EQUIP. SALES ! SERVICE BUILDING Proposed Use of Parcel: Estimated Start Date: Estimated Completion Date: OCTOBER 2, 2023 - Please submit 1 hard copy 24x38, 1 hard copy-11x17 and 1 PDF copy of the submittal. **SECTION 5: Certification and Permission** Certification: I hereby certify that I am the owner or authorized representative of the owner of the property which is the subject of this Permit Application. I certify that the information contained in this form and attachments is true and accurate. I certify that the project will be in compliance with all permit conditions. I understand that failure to comply with any or all of the provisions of the permit may result in permit revocation and a fine and/or forfeiture under the provisions of applicable laws. Permission: I hereby give the City permission to enter and inspect the property at reasonable times, to evaluate this notice and application, and to determine compliance with any resulting permit coverage. Name of Owner/Authorized Representative (please print) Phone Number DAVID J. GEHRT, ONE SOURCE CONSTRUCTION CORP. VICE PRESIDENT 262.784.1010 Signature of Applicant Date Signed AUGUST 23, 2023

@ THIS IS THE PROPOSED OWNER. CURRENT OWNER IS THE CITY OF DE PERE.

## TO BE COMPLETED BY CITY STAFF CSM Review authorized by the De Pere Municipal Code, Chapter 46.

## CITY OF DE PERE

335 South Broadway, De Pere, WI 54115 | www.de-pere.org



October 24, 2023

David Gehrt, Vice President One Source Construction CORP 3065 124<sup>th</sup> ST, Suite 202 Brookfield, WI 53005

RE: Revised Site Plan Review for the new Wolter INC at 1768 W Matthew DR (Parcel WD-364-D-505-8)

#### Dear David:

Thank you for the revised site plan for the new Wolter INC at 1768 W Matthew DR. The City of De Pere staff reviewed the site plan on October 24, 2023, and recommended approval with the following nine conditions that need to be addressed prior to obtaining occupancy permits:

- Sanitary lateral will need to be televised after constructed.
- Indicate water meter size meters greater than 1" may need to be special ordered and there could be a long lead time.
- Pressure and safe sample water service prior to valve being turned on.
- Storm sewer manhole in the eastern driveway may need to be upsized to a 6' diameter manhole to
  accommodate the 30" line (assuming there currently is a 5' diameter manhole). If this is required, the
  City would upsize the manhole and bill the developer. If the 30" line is downsized to a 24" line, the
  upsizing may not be required. Referencing WisDOT SDD 08B09
  - City to create a Public Infrastructure Improvement Agreement for this work. Please provide a schedule as to when this needs to be completed by.
- Any placement of trees in terrace will be first approved by City Forester and monitored on site at time
  of planting by the same.
- Sheet A0.1: The monument sign base must have a base that is at least 18" in height The base must be
  free of sign copy. The sign must incorporate design details, materials, and colors of the associated
  building.
- After exterior lighting is installed, provide a statement from the installer that the light spill from the property does not exceed the approved photometric plan.
- DPMC Chapter 42 Soil Erosion Control The site disturbance is more than one acre. WDNR/NOI permit is required prior to issuance of a soil erosion control permit. Soil erosion control shall be implemented 24 hours after site disturbance. All soil erosion control shall be maintained, inspected, accurate records maintained on a weekly basis and properly repaired and inspected after a precipitation event.
- DPMC 98-3 A Sign review and permit shall be obtained for any signs that require a permit prior to installation.

You may now proceed to the Inspection Division to begin the process of obtaining permits. Should you have any questions regarding the decision or require further information, feel free to contact me at 339-4043 or <a href="mailto:psechleinz@deperewi.gov">psechleinz@deperewi.gov</a>.

Sincerely,

Fuler Schlery

Peter Schleinz

Senior Planner | Zoning Administrator

cc: Daniel J. Lindstrom, AICP, Development Services Director

Dennis Jensen, Senior Building Inspector

WISCONSIN ADOPTED 2015 IBC

2 B

S-1/B

88,000sf

NON SEPARATED USE

NFPA 13 - COMPLETE

PROVIDE PER IFC

4 PROPOSED

8 PROPOSED

## GENERAL NOTES:

- THE FOLLOWING GENERAL AND SPECIFIC NOTES SHALL APPLY EQUALLY TO ALL CONTRACTORS AND SUPPLIERS ENGAGED IN THE EXECUTION OF THE WORK SHOWN ON THE CONTRACT DOCUMENTS.
- ALL CONTRACTORS ARE RESPONSIBLE TO VISIT THE SITE AND BECOME FAMILIAR WITH THE SITE CONDITIONS PRIOR TO THE START OF CONSTRUCTION.
- 3. THE GENERAL CONTRACTOR IS RESPONSIBLE TO VERIFY ALL DIMENSIONS, ELEVATIONS AND CONDITIONS PRIOR TO BEGINNING ANY WORK. NOTIFY THE ARCHITECT OF ANY DISCREPANCIES. DO NOT SCALE
- 4. REFER TO THE SOILS REPORT FOR SUBSURFACE CONDITIONS, BEARING CAPACITIES, ETC. NOTIFY THE ARCHITECT, ENGINEER AND OWNER OF ANY DISCREPANCY BETWEEN THIS REPORT AND THE PLANS, SPECIFICATIONS OR SITE CONDITIONS.
- 5. ALL WORK AND MATERIALS SHALL CONFORM TO THE LATEST BUILDING CODES, ORDINANCES AND REGULATIONS OF THE CITY OR COUNTY WITH JURISDICTION.
- EACH CONTRACTOR IS RESPONSIBLE FOR OBTAINING AND PAYING FOR THEIR PERMITS, LICENSES, INSPECTIONS AND TESTING AS REQUIRED BY THE CONTRACT DOCUMENTS OR ANY GOVERNMENT
- EACH CONTRACTOR IS TO PROVIDE ALL LABOR, MATERIALS, EQUIPMENT, TOOLS, TRANSPORTATION, UTILITIES, OTHER SERVICES AND RELATED TASKS NECESSARY FOR PROPER EXECUTION OF THE CONSTRUCTION REQUIRED BY THE SCOPE OF THEIR CONTRACT DOCUMENTS.
- . EACH CONTRACTOR IS RESPONSIBLE FOR JOBSITE CONDITIONS. TO COMPLY WITH SAFETY REGULATIONS AND RESTRICTIONS AS REQUIRED FOR WORKER AND PEDESTRIAN PROTECTION DURING THE COURSE OF CONSTRUCTION OF THIS PROJECT. PROVIDE PROTECTION AS REQUIRED TO PREVENT ANY DAMAGE TO EXISTING CONSTRUCTION WITHIN AND ADJACENT TO THE JOBSITE. WHERE DAMAGE OCCURS, REPAIR OR REPLACE DAMAGED AREA AND/OR MATERIAL AS REQUIRED TO THE OWNER'S APPROVAL AT NO ADDITIONAL COST. THESE REQUIREMENTS SHALL APPLY CONTINUOUSLY AND NOT BE LIMITED TO NORMAL
- 9. UNLESS OTHERWISE SHOWN OR NOTED, THE GENERAL CONTRACTOR SHALL BE RESPONSIBLE FOR COORDINATING THE LOCATION AND THE PLACEMENT OF ANY INSERTS, HANGARS, PIPE SLEEVES, HOLES OR ANCHOR BOLTS THAT ARE REQUIRED BY THE MECHANICAL, PLUMBING, SPRINKLER OR ELECTRICAL
- 10. BRING ANY REVISION(S) OR ADDITIONAL WORK REQUIRED BY FIELD CONDITIONS OR LOCAL GOVERNING AUTHORITIES TO THE ATTENTION OF THE ARCHITECT, GENERAL CONTRACTOR AND OWNER BEFORE
- II. VERIFY THE SIZE AND LOCATION OF ALL UTILITY LINES AND STUBS TO THE BUILDING. BRING ALL UTILITY LINES (WATER, SEWER, GAS, STORM DRAIN, TELEPHONE AND ELECTRICAL, ETC.) INTO THE BUILDING AS INDICATED ON THE CONSTRUCTION DOCUMENTS. BRING ANY DISCREPANCIES TO THE ATTENTION OF THE ARCHITECT, GENERAL CONTRACTOR, OWNER & CIVIL ENGINEER.
- 12. UNLESS NOTED OTHERWISE, ALL DETAILS, SECTIONS, AND NOTES ON THE DRAWINGS ARE INTENDED TO BE TYPICAL FOR SIMILAR SITUATIONS ELSEWHERE.
- 13. THE REMOVAL OF ALL HAZARDOUS CONTAINING MATERIALS IS THE SOLE RESPONSIBILITY OF THE OWNER. SHOULD ANY MATERIALS BE ENCOUNTERED DURING ANY PHASE OF CONSTRUCTION, OR SUSPECTED TO BE HAZARDOUS, THE CONTRACTOR SHALL STOP WORK IMMEDIATELY AND NOTIFY OWNER.

# A NEW BUILDING FOR Wolter, Inc.


1768 West Matthew Drive DePere, WI 54115





3065 N. 124th Street, Brookfield, WI 53005

262.784.1010 ph 262.784-9083fax

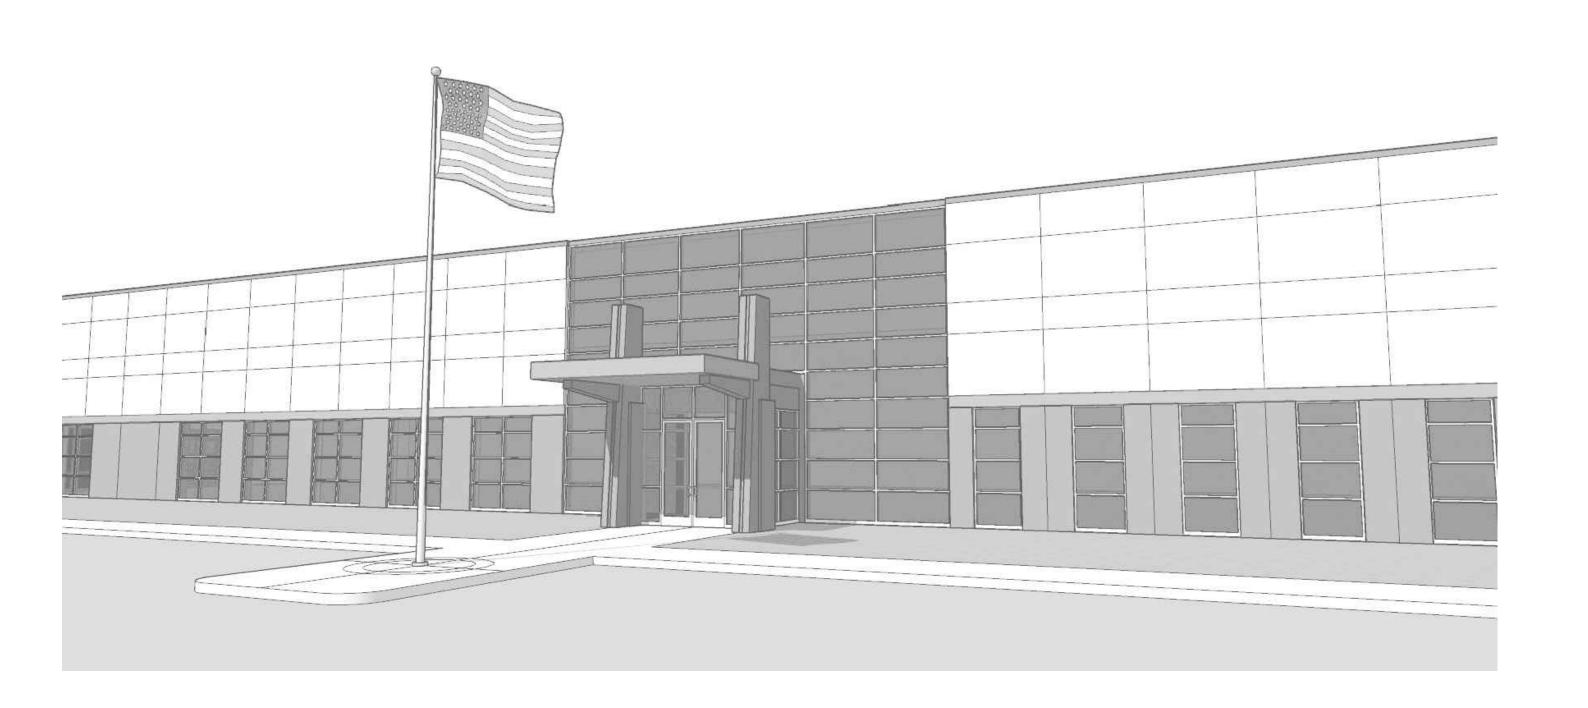

## SHEET INDEX:

ARCHITECTURAL SITE PLAN GRADING PLAN

PROJECT INFORMATION:

388 TOTAL OCCUPANTS IN BUILDING

(14,600sf/100 = 146)

(72,000sf/300 = 240)

(B-BUSINESS AREAS = 1 PER 100 S.F)

= 3.16 REQUIRED

= 3.16 REQUIRED

= 6.05 REQUIRED

STRUCTURAL

(STORAGE, STOCK, SHIPPING = 1 PER 300 S.F)

(25 / 25) = 1 REQUIRED (48 / 50) = 0.96

(25 / 25) = 1 REQUIRED (48 / 50) = 0.96

(146/40) = 3.65 REQUIRED

(120 / 100) = 1.2 REQUIRED

(120/100) = 1.2 REQUIRED

(240 / 100) = 2.4 REQUIRED

GOVERNING CODE:

CONSTRUCTION TYPE:

SPRINKLER SYSTEM:

ACCESSIBLE ROUTE:

OCCUPANCY CLASSIFICATION:

ALLOWABLE AREA PER FLOOR:

TOTAL OCCUPANCY LOADING

(per TABLE 1004.1.1)

PLUMBING FIXTURE REQUIREMENTS:

WATER CLOSETS "TOTAL REQUIRED" = 10

WATER CLOSETS "B BUSINESS"

WATER CLOSETS "S-I REPAIR"

MALE (1 PER 25)

FEMALE (1 PER 25)

LAVATORIES (1 PER 40)

MALE (1 PER 100)

LAVATORIES (1 PER 100)

FEMALE (1 PER 100)

(per TABLE 2902.1)

FEMALE

LAVATORIES

ACCESSIBLE RESTROOMS & FIXTURES:

OCCUPANCY SEPARATION:

C-3 EROSION CONTROL PLAN UTILITY & PAVING PLAN CONSTRUCTION DETAILS CONSTRUCTION DETAILS

LANDSCAPING SHEETS: LGD I .O LANDSCAPING GENERAL NOTES LSPI.I LANDSCAPE PLAN

LANDSCAPE PLAN LSP1.3 PLANTING DETAILS PHOTOMETRIC PLAN PHO I.2 PHOTOMETRIC PLAN

### ARCHITECTURAL SHEETS:

ARCHITECTURAL SITE PLAN DETAILED SITE PLAN

PHO I . 3 PROPOSED LIGHT FIXTURES

FLOOR PLAN A I . I ROOF PLAN A1.2 ELEVATIONS SECTIONS A3.1

PROJECT TEAM:

OWNER: Wolter Investment Company LLC 3125 Intertech Dr. Brookfoeld, WI 53045 TEL: (262) 781-8010

email steve.kletzien@wolterinc.com

ATTN: Steven Kletzien

ARCHITECT / STRUCTURAL ENGINEER: PATERA, LLC

4040 N. CALHOUN RD. SUITE 200 BROOKFIELD, WI 53005 TEL: (262) 786-6776 email steve@paterallc.com ATTN: Steven M. Esser

GENERAL CONTRACTOR:

One Source Construction Corporation 3065 N. 124th St., Suite 202 Brookfield, WI 53005 TEL: (262) 784-1010 email daveq@osccinc.com ATTN: David J. Gehrt

CIVIL: Payne + Dolan PO Box 781 Waukesha, WI 53187 TEL: (920) 757-7561

email skolar@walbecgroup.com

ATTN: Steve Kolar, P.E.

SITE LIGHTING \$ LANDSCAPE DESIGN InSite Landscape Design, Inc. 11525 W. North Ave, Suite 1b


Wauwatosa, WI 53226 TEL: (414) 476-1204 email mdavis@insitedesigninc.com ATTN: Michael C. Davis

## SITE PLAN GENERAL NOTES:

- ALL PAVING RADII SHALL BE 4'-0" UNLESS NOTED
- 2. PROVIDE CONCRETE SIDEWALKS AS INDICATED ON 3. UTILITY DESIGN AND WORK BY DESIGN / BUILD
- CONTRACTOR. GRADING AT ACCESSIBLE ROUTE TO COMPLY WITH THE WISCONSIN ADOPTED 2015 IBC CHAPTER II AND THE
- 2009 ANSI 117.1 DESIGN GUIDELINES. FINISHED FLOOR ELEVATION = 100'-0" ON
- ARCHITECTURAL DRAWINGS VERIFY ACTUAL ELEVATION WITH CONTRACTOR 6. SITE ENGINEERING (GRADING, STORM WATER DRAINAGE,
- ETC.) BY OTHERS ALL PROPERTY LINE BEARINGS AND LENGTHS BASED ON OWNER AND CONTRACTOR PROVIDED DATA.
- 8. CONSTRUCTION SITE EROSION AND SEDIMENTATION CONTROL SHALL COMPLY WITH THE REQUIREMENTS OF THE TOWN/VILLAGES/CITY AND SHALL EMPLOY EROSION CONTROL METHODS AS SHOWN AND SPECIFIED IN THE DEPARTMENT OF NATURAL RESOURCES WISCONSIN CONSTRUCTION SITE BEST MANAGEMENT PRACTICES HANDBOOK (BMP HANDBOOK).
- 9. ALL EROSION CONTROL MEASURES SHALL BE ADJUSTED TO MEET FIELD CONDITIONS AT THE TIME OF CONSTRUCTION AND SHALL BE INSTALLED PRIOR TO ANY GRADING OR DISTURBANCE OF EXISTING SURFACE MATERIAL ON THE SITE.
- IO. PERIODIC INSPECTION AND MAINTENANCE OF ALL EROSION CONTROL STRUCTURES SHALL BE PROVIDED TO INSURE INTENDED PURPOSE IS ACCOMPLISHED. CONTRACTOR SHALL BE RESPONSIBLE FOR CLEANUP AND REMOVAL OF ALL SEDIMENT LEAVING PROPERTY. EROSION CONTROL MEASURES SHALL BE IN WORKING CONDITION AT END OF EACH WORK DAY. EROSION CONTROL MEASURES SHALL BE MAINTAINED ON A CONTINUING BASIS UNTIL SITE IS FULLY STABILIZED.
- I. SILT FENCE SHALL BE INSTALLED IN ALL LOCATIONS WHERE POTENTIAL RUNOFF AND CONTAMINATION MAY
- 12. ALL EROSION AND SEDIMENT CONTROL PRACTICES TO BE CHECKED FOR STABILITY AND OPERATION FOLLOWING EVERY RUNOFF-PRODUCTION RAINFALL EVENT. ANY NEEDED REPAIRS REPAIRS SHALL SHALL BE MADE IMMEDIATELY TO MAINTAIN ALL PROTECTION AS DESIGNED.
- 13. SEDIMENT IS TO BE REMOVED FROM BEHIND THE

#### SITE PLAN CODED NOTES:

- PROVIDE RESERVED PARKING SIGN IN ACCORDANCE WITH TRANS. 200.07 OF THE WISCONSIN ADMINISTRATIVE CODE. 12"x18" min. SIZE REQUIRED AT EACH H.C. ACCESSIBLE PARKING STALL (REFER TO 5/AO.2)
- 2 PROVIDE RESERVED VAN ACCESSIBLE PARKING SIGN IN ACCORDANCE WITH TRANS. 200.07 OF THE WISCONSIN ADMINISTRATIVE CODE. 12"x18" min. SIZE REQUIRED AT EACH H.C. ACCESSIBLE PARKING STALL (REFER TO 5/AO.2)
- 3 ACCESSIBLE PARKING AND ACCESSIBLE PAVED AREA: AREA SHALL HAVE A SLOPE NO GREATER THAN 1:50 (2%) IN ANY DIRECTION, AND SHALL BE SLOPED TO DRAIN AWAY FROM CURBS AND/OR SIDEWALKS.
- 4 PAINTED INTERNATIONAL SYMBOL OF ACCESSIBILITY IN ACCORDANCE WITH
- ADAAG 4.30.7(I). (REFER TO DETAIL 7/AO.2) (5) PROVIDE 4" WIDE PAINTED STRIPING AS INDICATED ON PLAN. PAINT SHALL BE "TRAFFIC YELLOW" PL-4666.
- $\langle 6 \rangle$  SIDEWALK TO BE FLUSH WITH PARKING LOT PAVING AT (STRIPED) ACCESSIBLE WALK PATH
- (7) ACCESSIBLE PATH OF TRAVEL.
- (8) ADA COMPLIANT ACCESS CURB CUT, REFER TO DETAIL 10/AO.2.
- 9) ANODIZED ALUMINUM FLAG POLE, 30' POLE (VERIFY W/ OWNER)
- $\rangle$  PROVIDE 6" HIGH CONCRETE CURB.
- (11) 8" THICK CONCRETE TRUCK DOCK RAMP. W 6x6 -W2.9 xW2.9 WWF ON 8" LAYER OF FREELY DRAINING COMPACTED GRANULAR BASE COURSE. DOWEL INTO ADJACENT FOUNDATION AS REQUIRED. SLOPE RAMP TO DRAIN
- (12) 12" WIDE TRENCH DRAIN AND GRATE, PITCH CONCRETE TO GRATE. REFER TO STRUCTURAL'S FOR REINFORCEMENT AND DETAIL
- (3) CONCRETE MONUMENT SIGN BASE. SIGNAGE AND GRAPHICS BY OTHERS -
- $\langle \overline{14} \rangle$  Ix6 x 8'-0" HIGH CEDAR FENCE ON GALVANIZED STEEL FRAME.
- (15) CONCRETE SIDEWALK. REFER TO DETAIL 6/AO.2.
- (16) CONCRETE CURB / SIDEWALK. REFER TO DETAIL 3/AO.2.

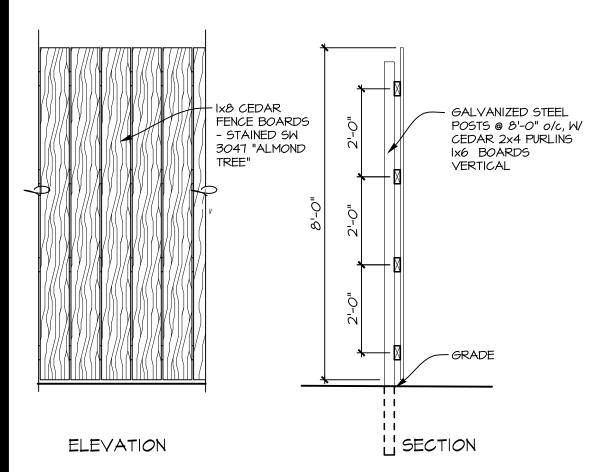

DUMPSTER ENCLOSURE DETAILS

MONUMENT SIGN


GRAPHICS BY MANUFACTURER PAINTED METAL FRAME BY SIGN MANUFACTURER -PAINTED METAL 10'-0" FOUNDATION WALL W/ (2) #4 TOP AND BOTTOM. \_\_\_\_\_\_\_\_

SCALE: ½" = 1'-0"

SEDIMENT FENCE WHEN IT BECOMES .05 FEET DEEP AT THE FENCE. REPAIR THE FENCE AS NECESSARY TO MAINTAIN BARRIER.

14. SEE ALL RELATED DETAILS AND REMAINING SHEETS SPECIFICATION FOR ADDITIONAL INFORMATION AND HOW IT RELATES TO THE SCOPE OF THE PROJECT.

15. ADDITIONAL GRADING OF GRASSED OR LANDSCAPED AREAS MAY BE REQUIRED DUE TO THE PLUMBING, SANITARY OR OTHER UNDERGROUND UTILITY WORK -REVIEW DOCUMENTS IN THEIR ENTIRETY TO DETERMINE

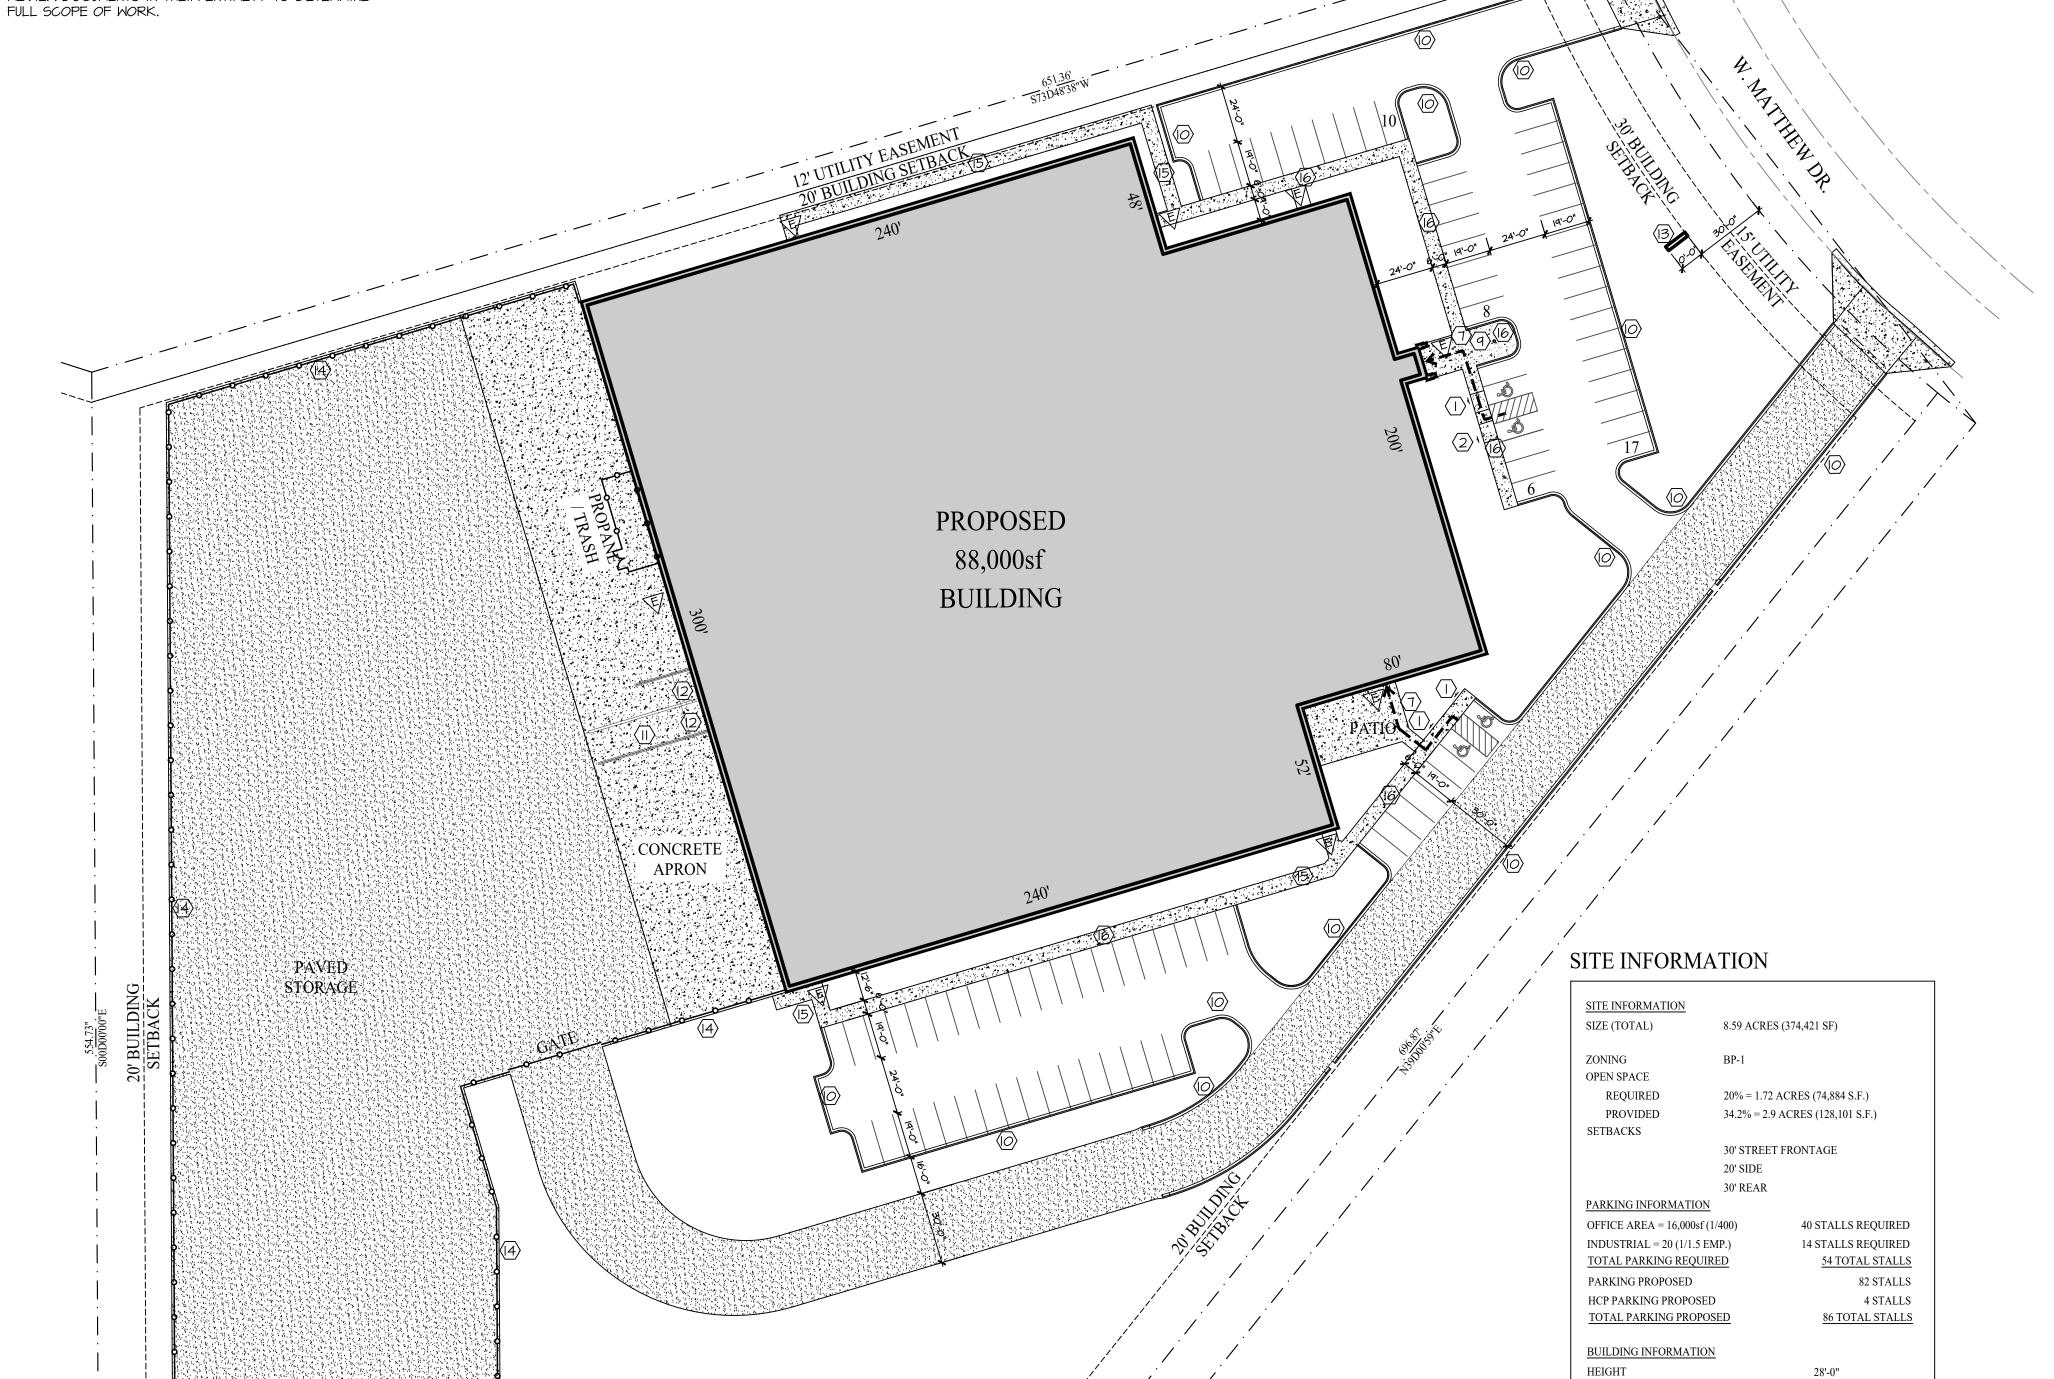

SQUARE FOOTAGE 88,000 SQ.FT SITE LEGEND POURED CONCRETE BUILDING FOOTPRINT . AUTO PAVING TRUCK PAVING PROPERTY LINE BUILDING SET BACK ----------

PARKING SET BACK EXIT LOCATIONS ACCESSIBLE PATH OF TRAVEL SPOT ELEVATION


PRELIMINARY CONCEPTUAL SITE PLAN


30' BUILDING

**REVISIONS:** 


PROJECT NUMBER: 23-203


SCALE: ½" = 1'-0"

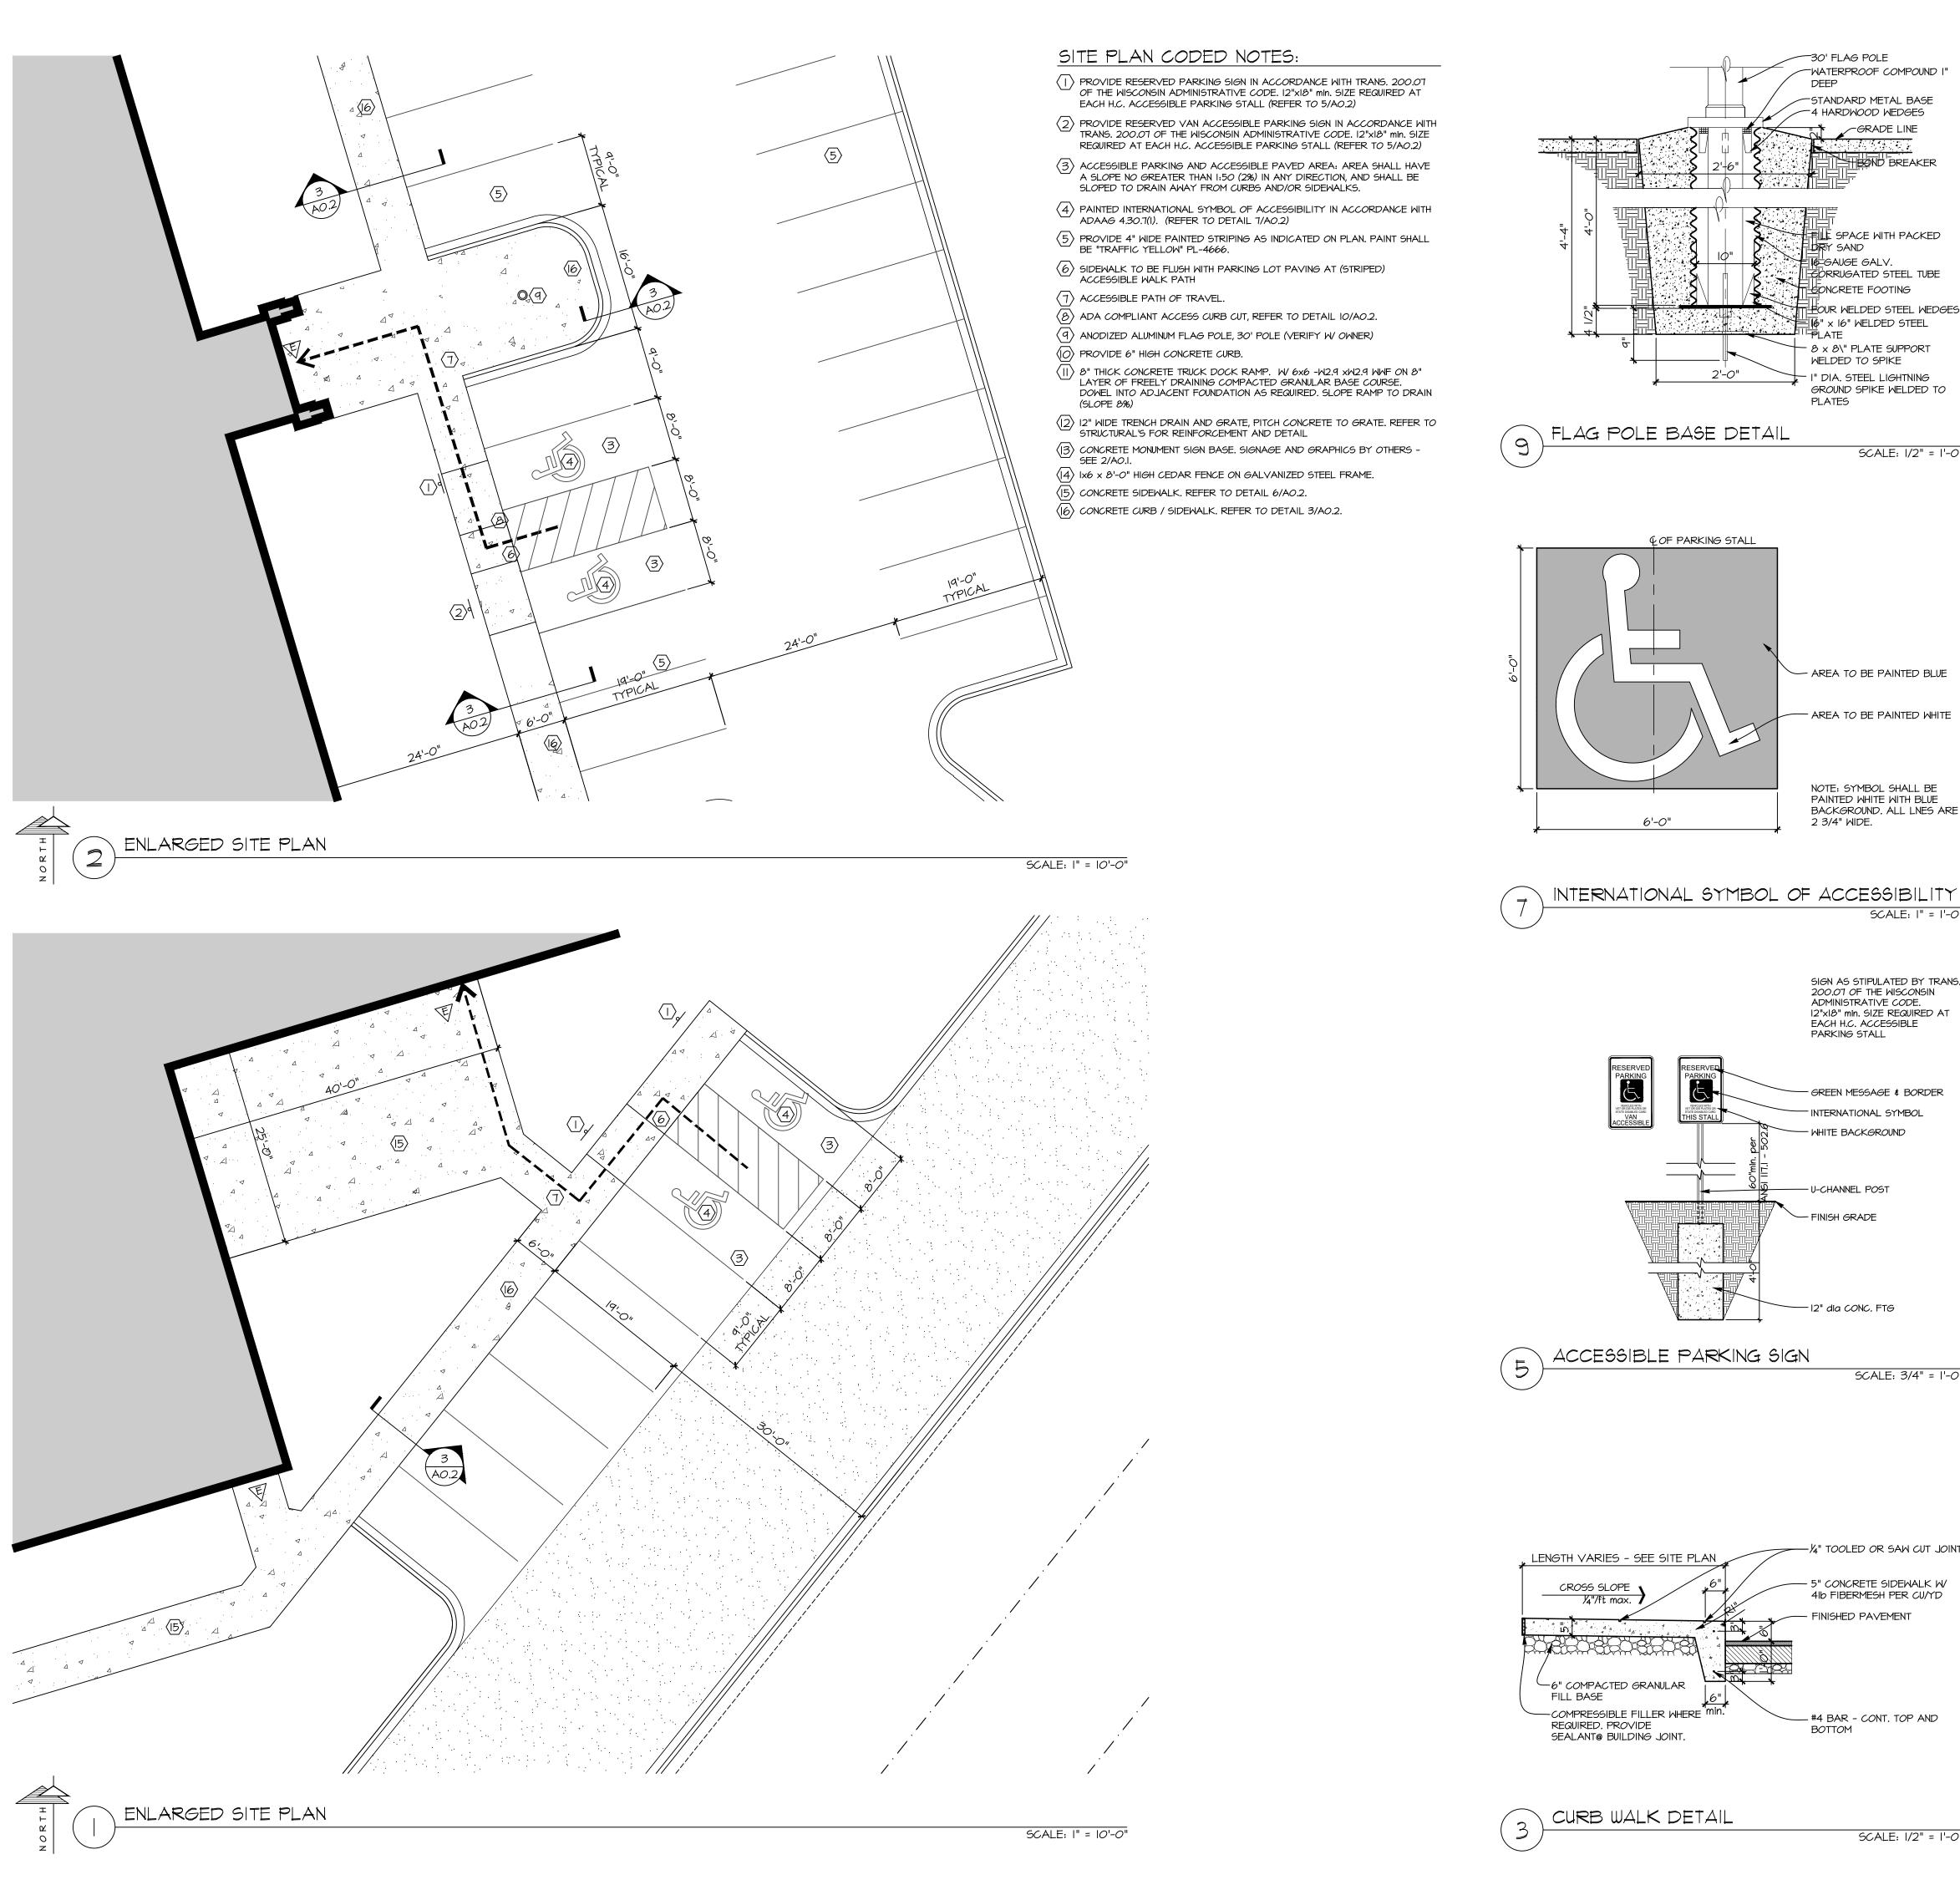

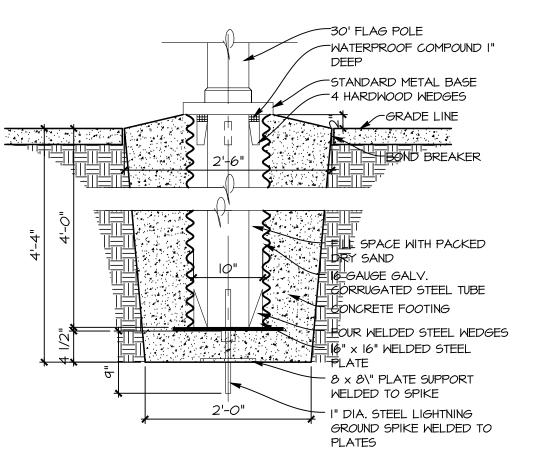




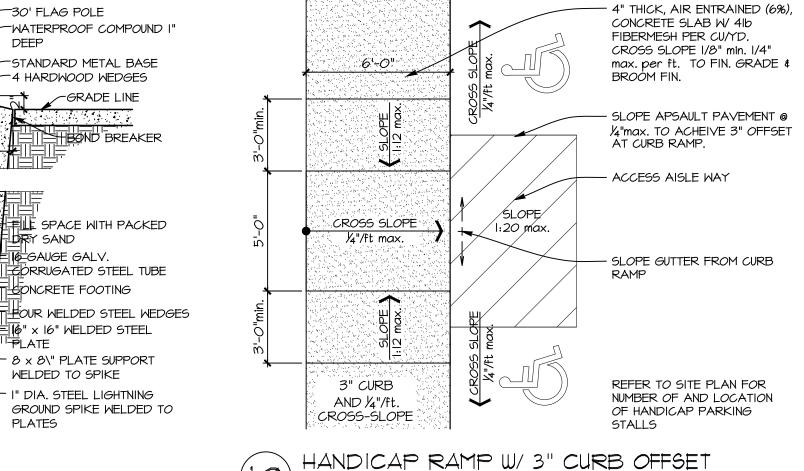

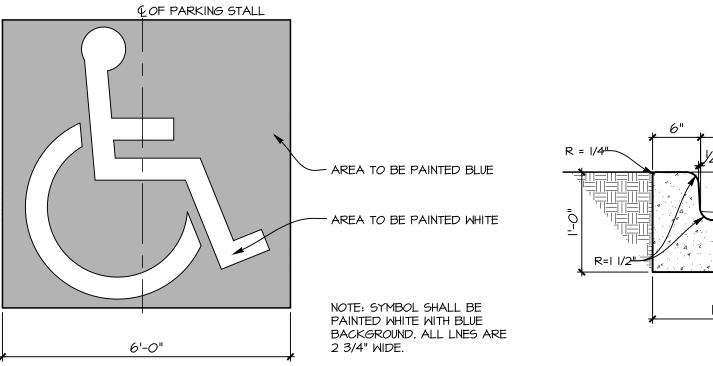

SCALE: 1/2" = 1'-0"

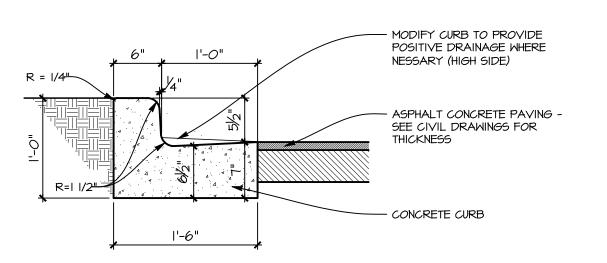

CONCRETE CURB & GUTTER DETAIL

SCALE: 1/4" = 1'-0"


SCALE: I" = I'-0"


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**REVISIONS:** 


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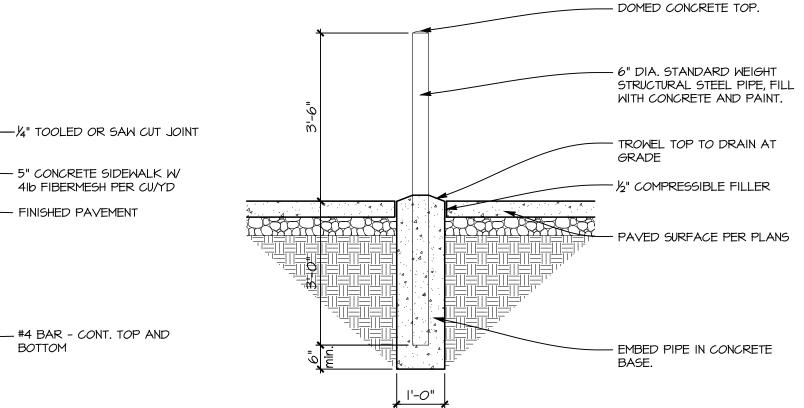






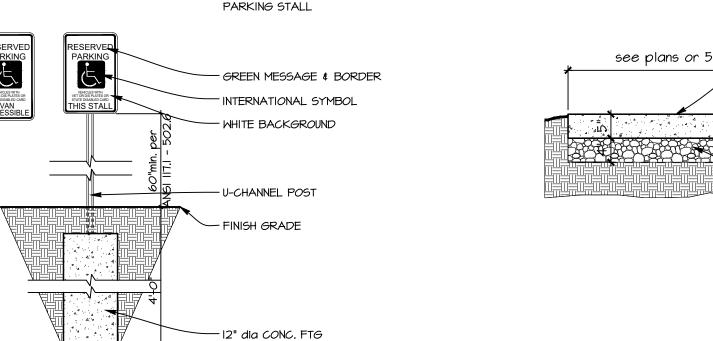

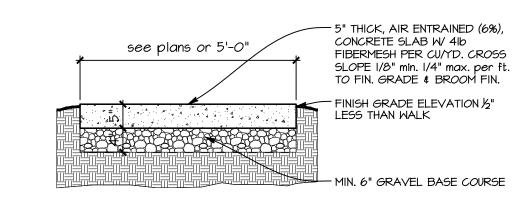

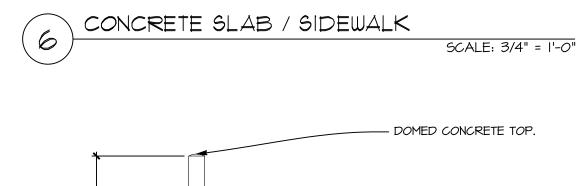

CURB WALK DETAIL SCALE: 1/2" = 1'-0"

**BOTTOM** 


PIPE BOLLARD DETAIL

. 9


TLE:

DATE: 10/06/2023

SCALE: 1/2" = 1'-0" PROJECT NUMBER: 23-203

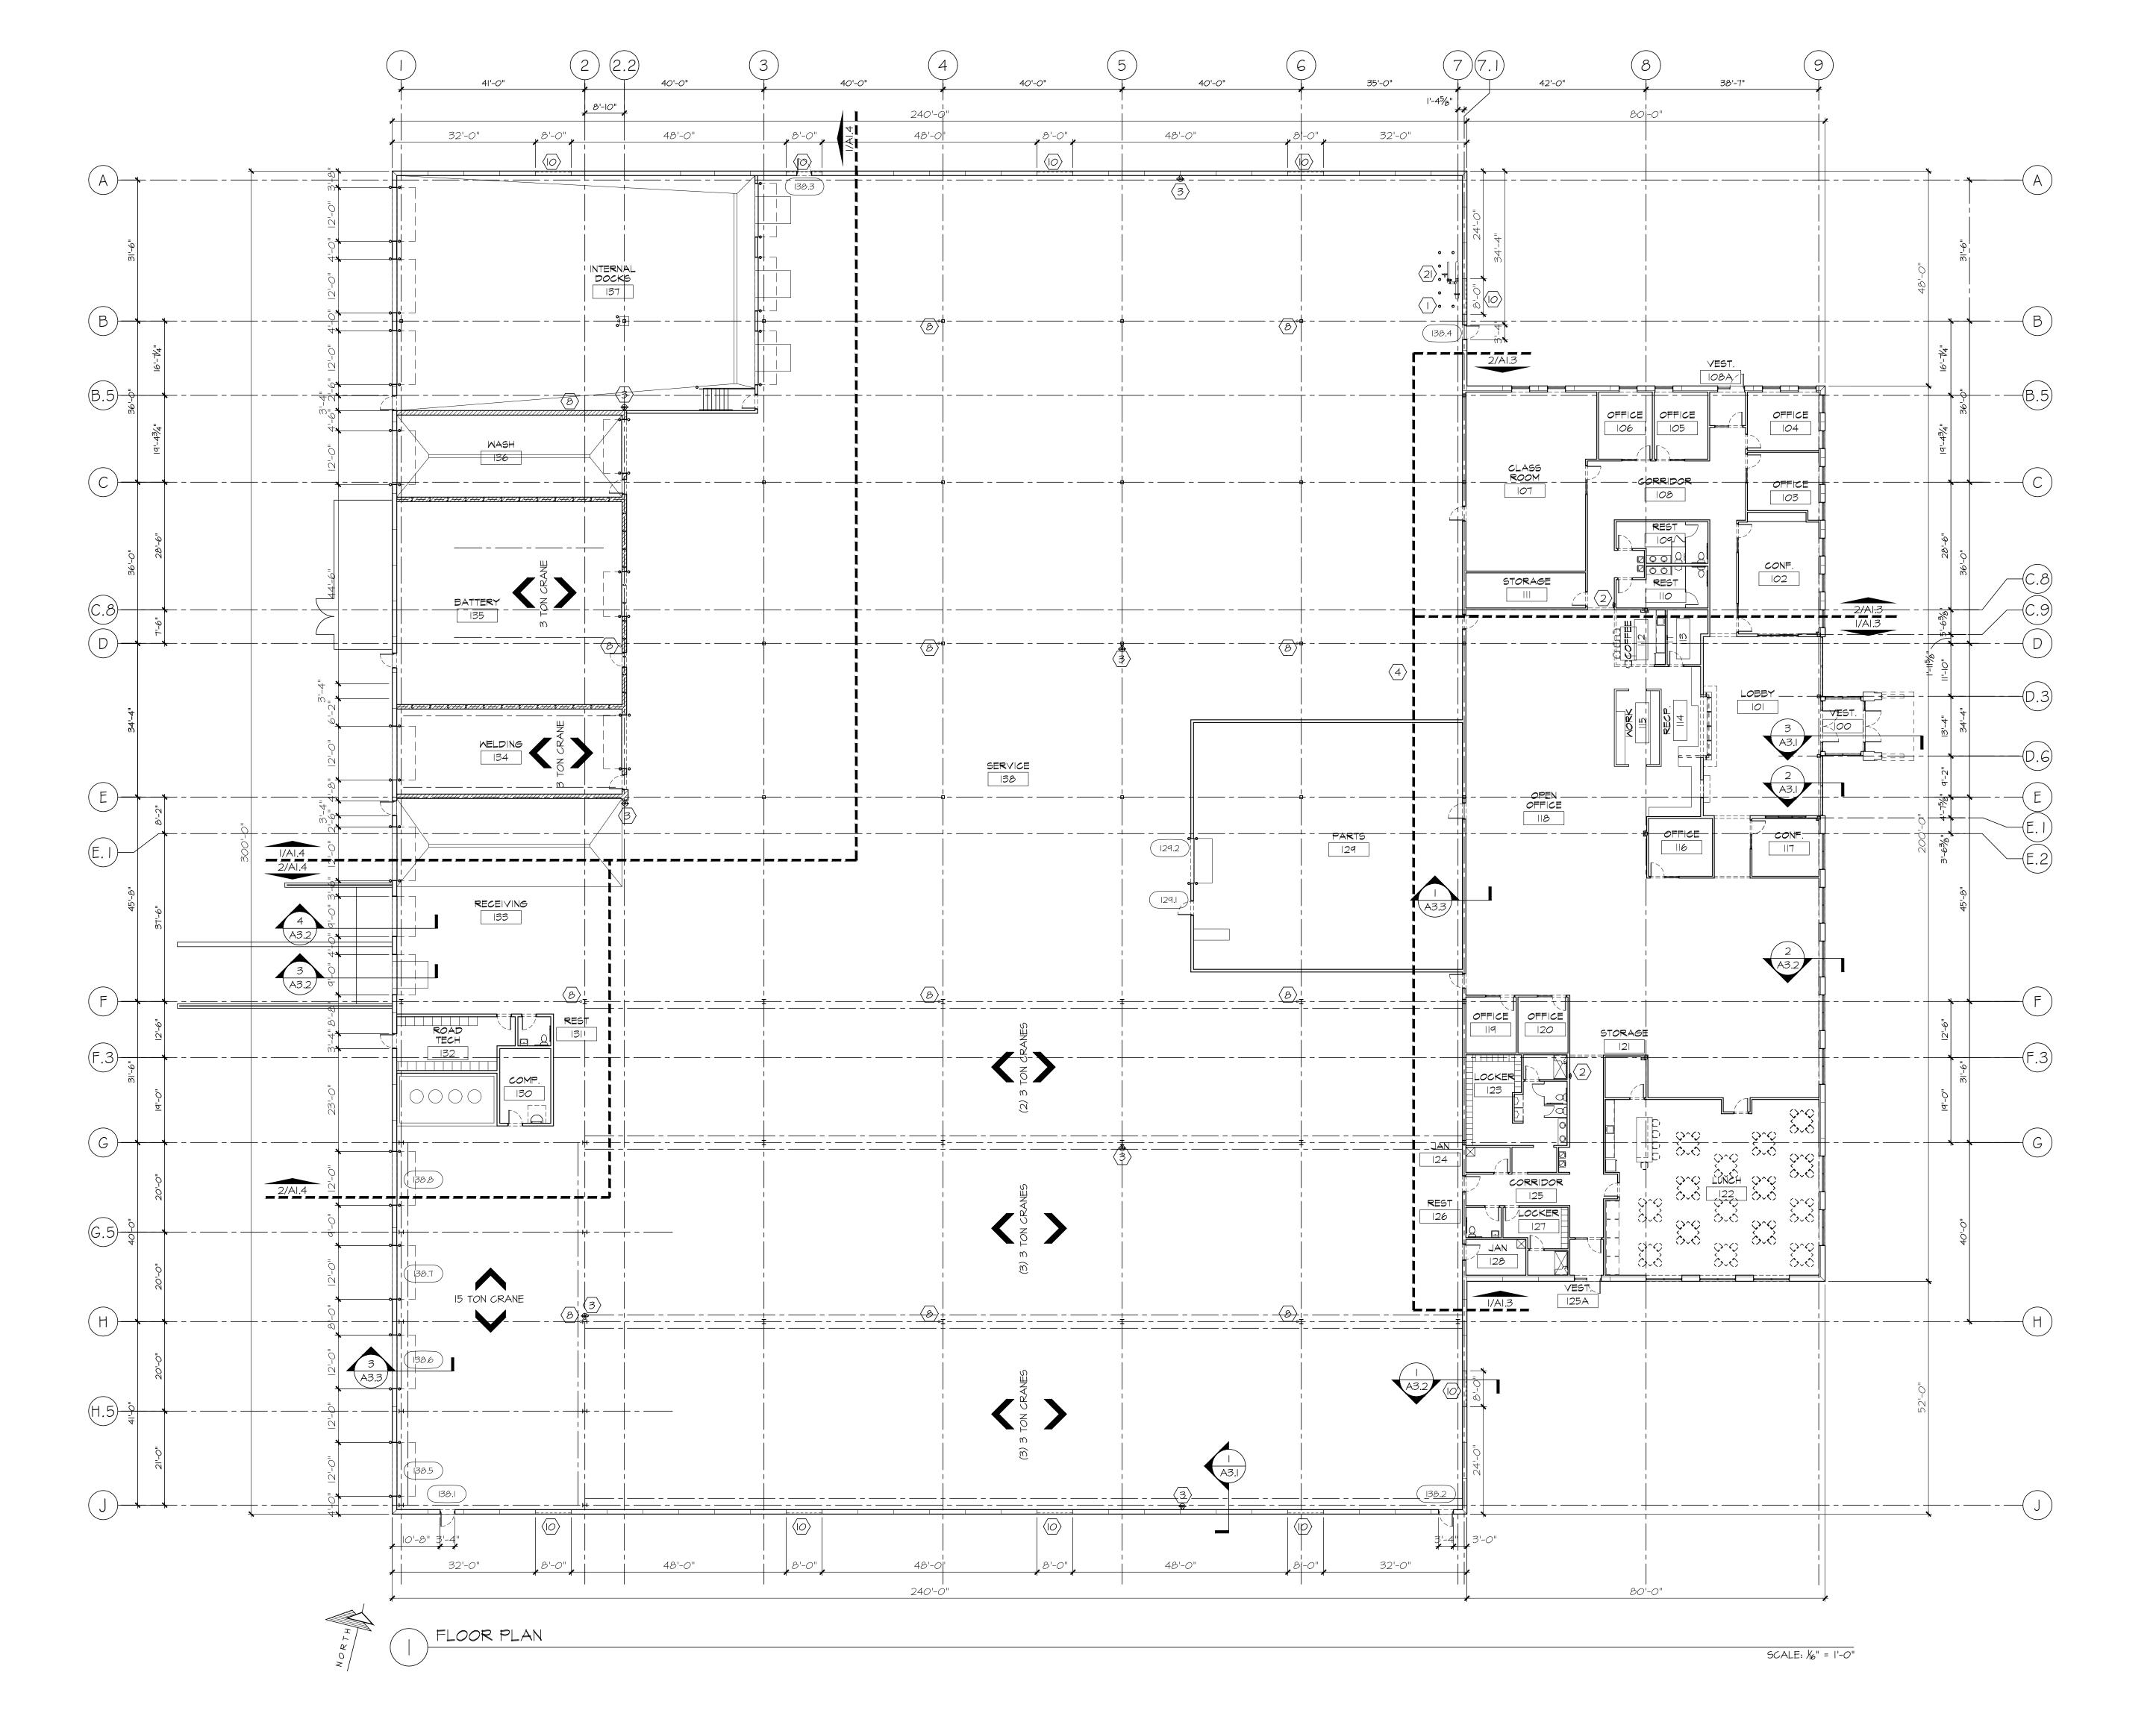

NOT

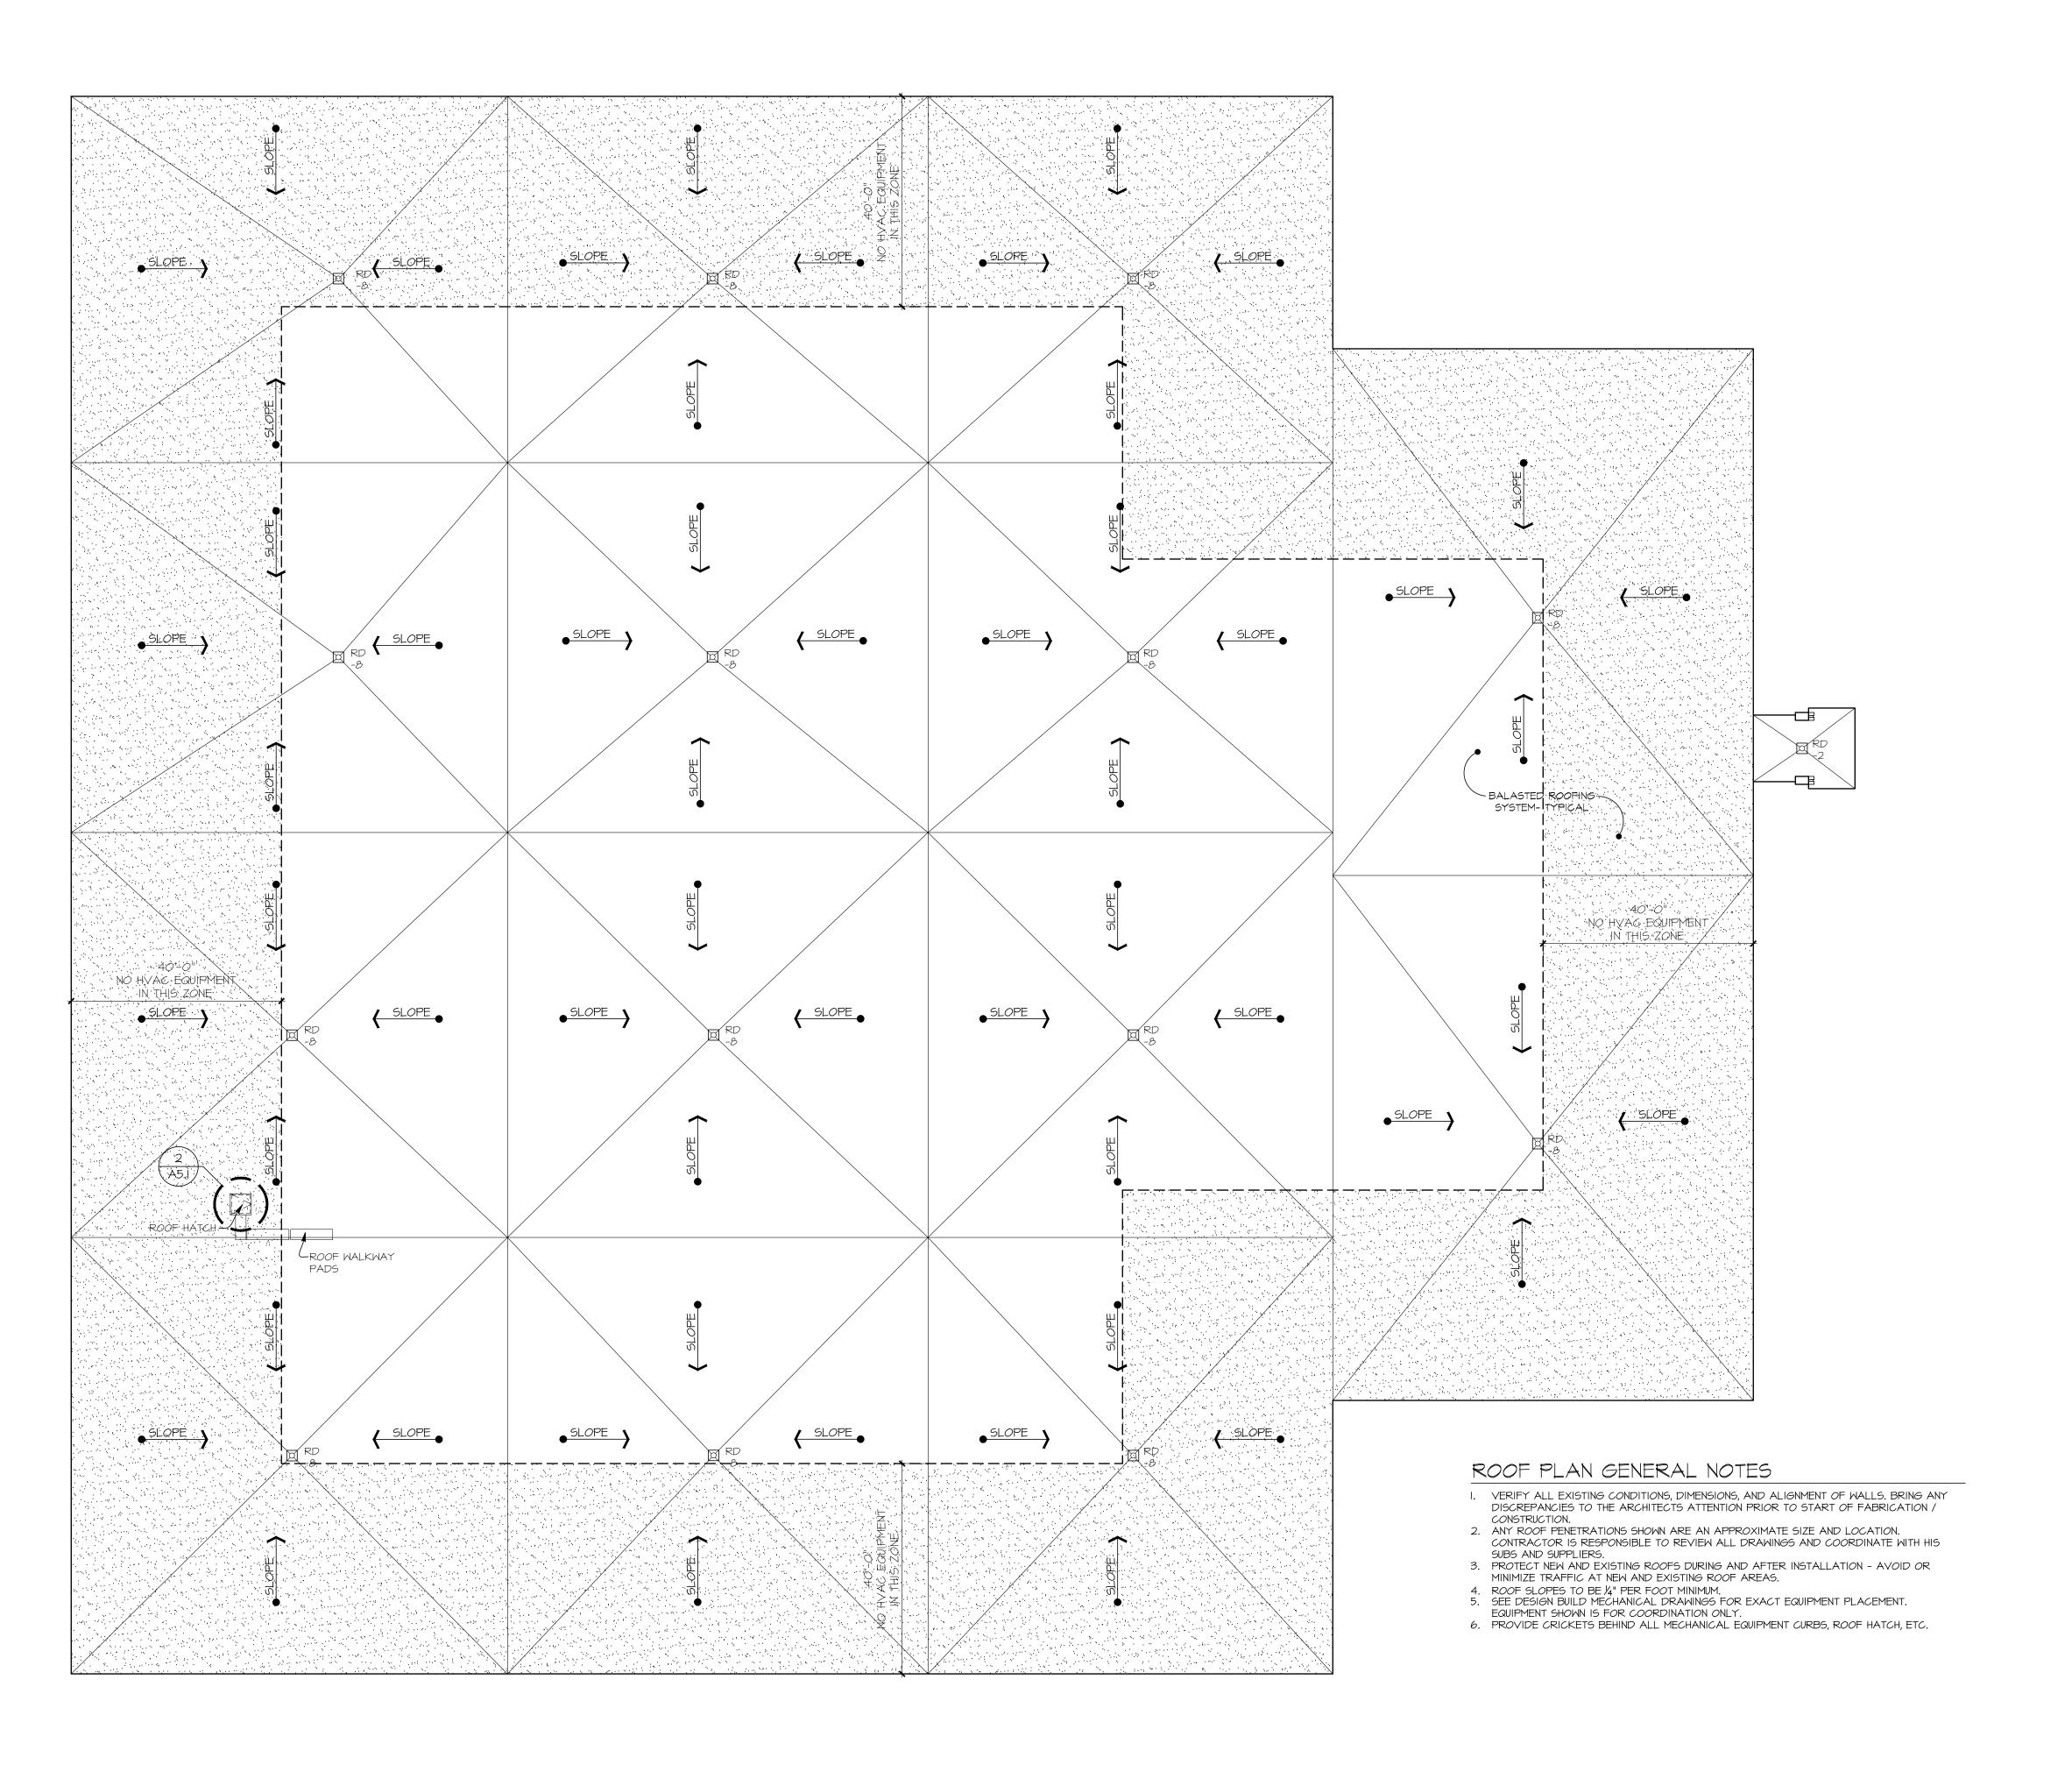

NOT

## ELEVATION GENERAL NOTES

- CONTRACTOR TO FIELD VERIFY ALL ROUGH OPENINGS.
- WINDOW SYSTEM TO BE EXTERIOR GLAZED.
- ALL EXTERIOR MATERIALS TO BE APPROVED BY THE
- ARCHITECT BEFORE INSTALLTION.
  4. ALL MASONRY, PRECAST CONCRETE, EIFS, etc SHALL HAVE CONTROL JOINTS SPACED PER INSTITUTE MINUMUM STANDARDS. CONTACT ARCHITECT FOR LOCATIONS NOT INDICATED ON THE

## ELEVATION LEGEND

- VISION GLASS


- SPANDREL GLASS


T - TEMPERED GLASS C.J. - CONTROL JOINT


A - WINDOW TYPE. REFER TO SHEET A8.2.

### ELEVATION CODED NOTES:

- 8' WIDE EXPOSED AGGREGATE PRE-CAST CONCRETE PANEL NOT PAINTED
- $\langle 2 \rangle$  2" HORIZONTAL REVEAL BAND (3) 12" REVEAL PAINTED WOLTER RED
- 4 PRE FINISHED METAL COPING COLOR GREY
- $\langle 5 \rangle$  INSULATED OVER HEAD DOOR WITH VISION LITE COLOR WHITE
- (6) ALUMINUM WINDOW SYSTEM COLOR BLACK ANODIZED
- $\langle$  7angle8' WIDE EXPOSED AGGREGATE PRE-CAST CONCRETE PANEL -PAINT BOTTOM 10'-0" WOLTER GREY
- (8) INSULATED HOLLOW METAL DOOR PAINTED TO MATCH
- PRECAST CONCRETE. (9) PRE FINISHED METAL COPING - WOLTER RED
- (IO) CONCRETE ENTRY COLUMN PAINTED WOLTER GREY
- SPANDREL GLASS TO MATCH VISION GLASS TOP TWO ROWS OF GLAZING.

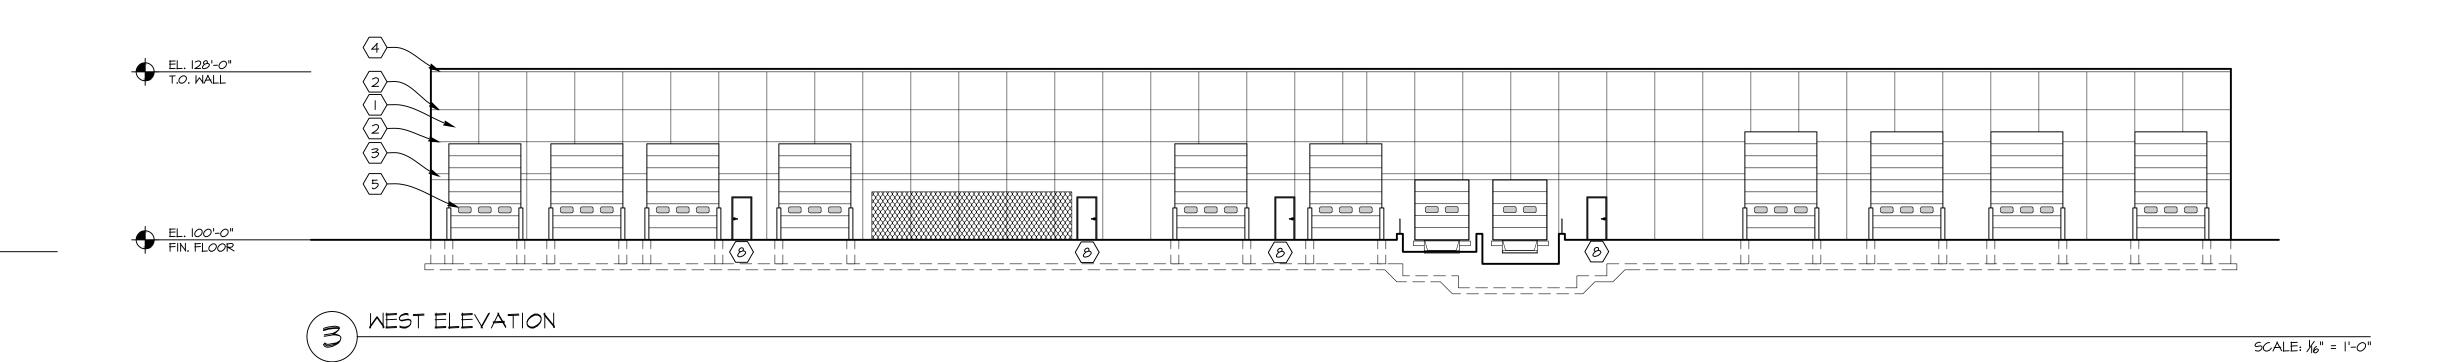

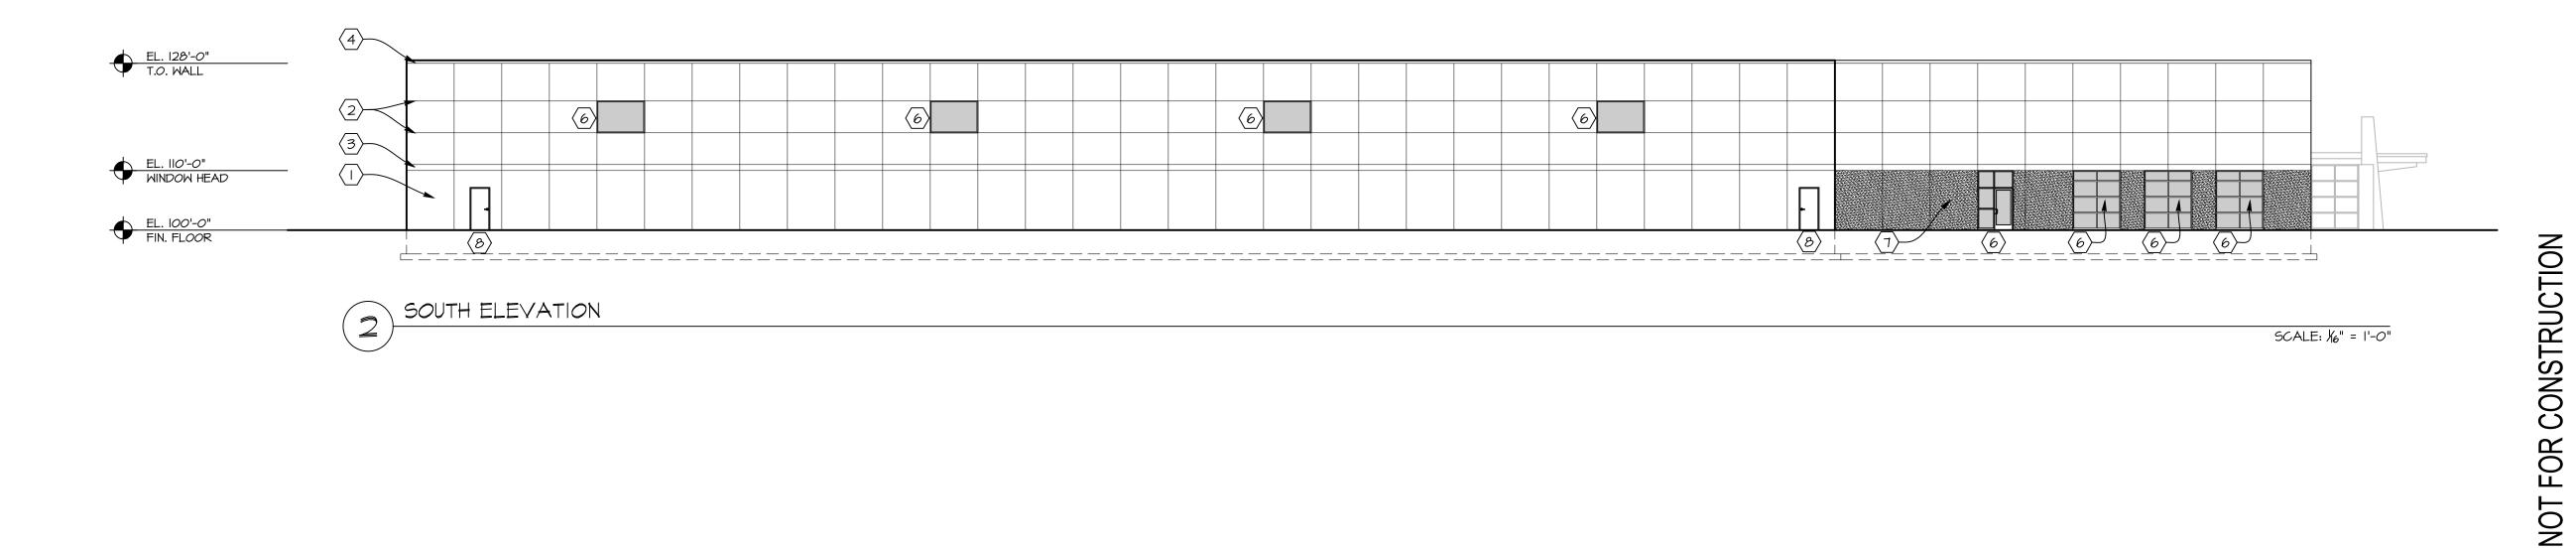


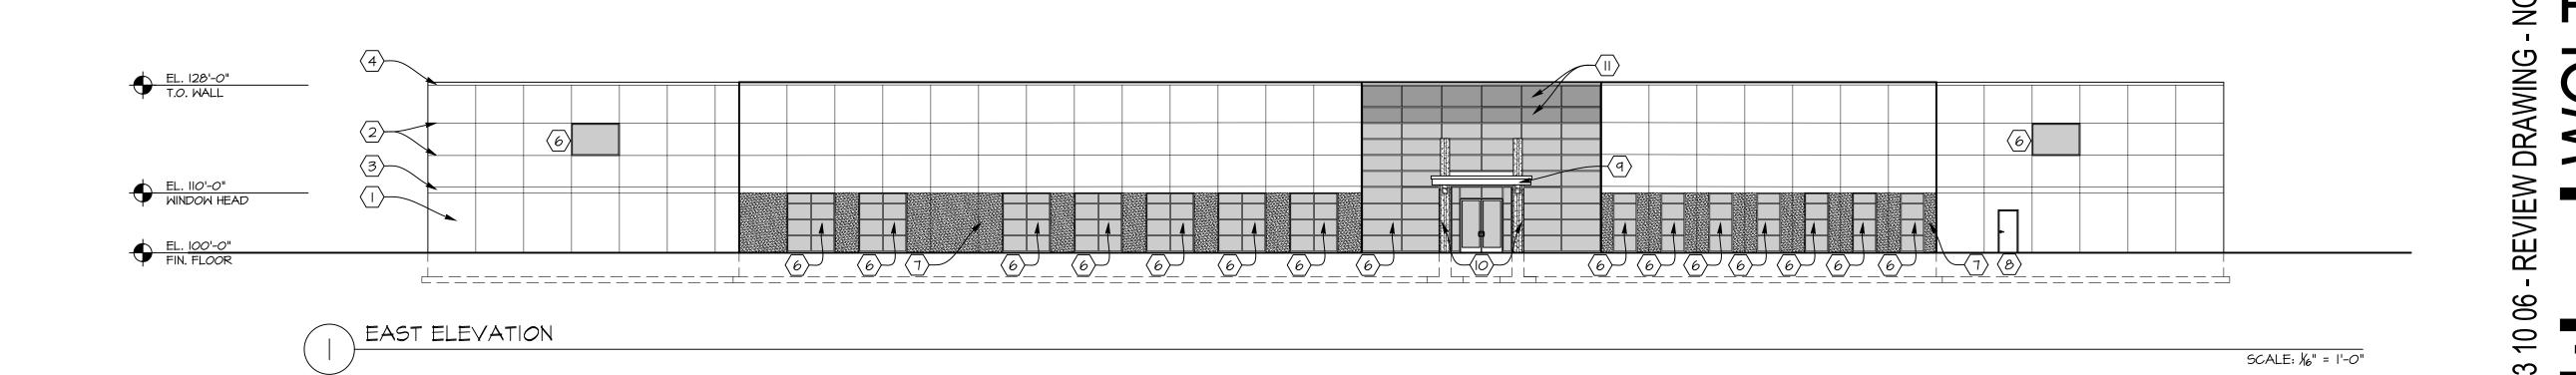

**REVISIONS:** - X

SHEET TITLE: ELEVATIONS

DATE: 10/06/2023

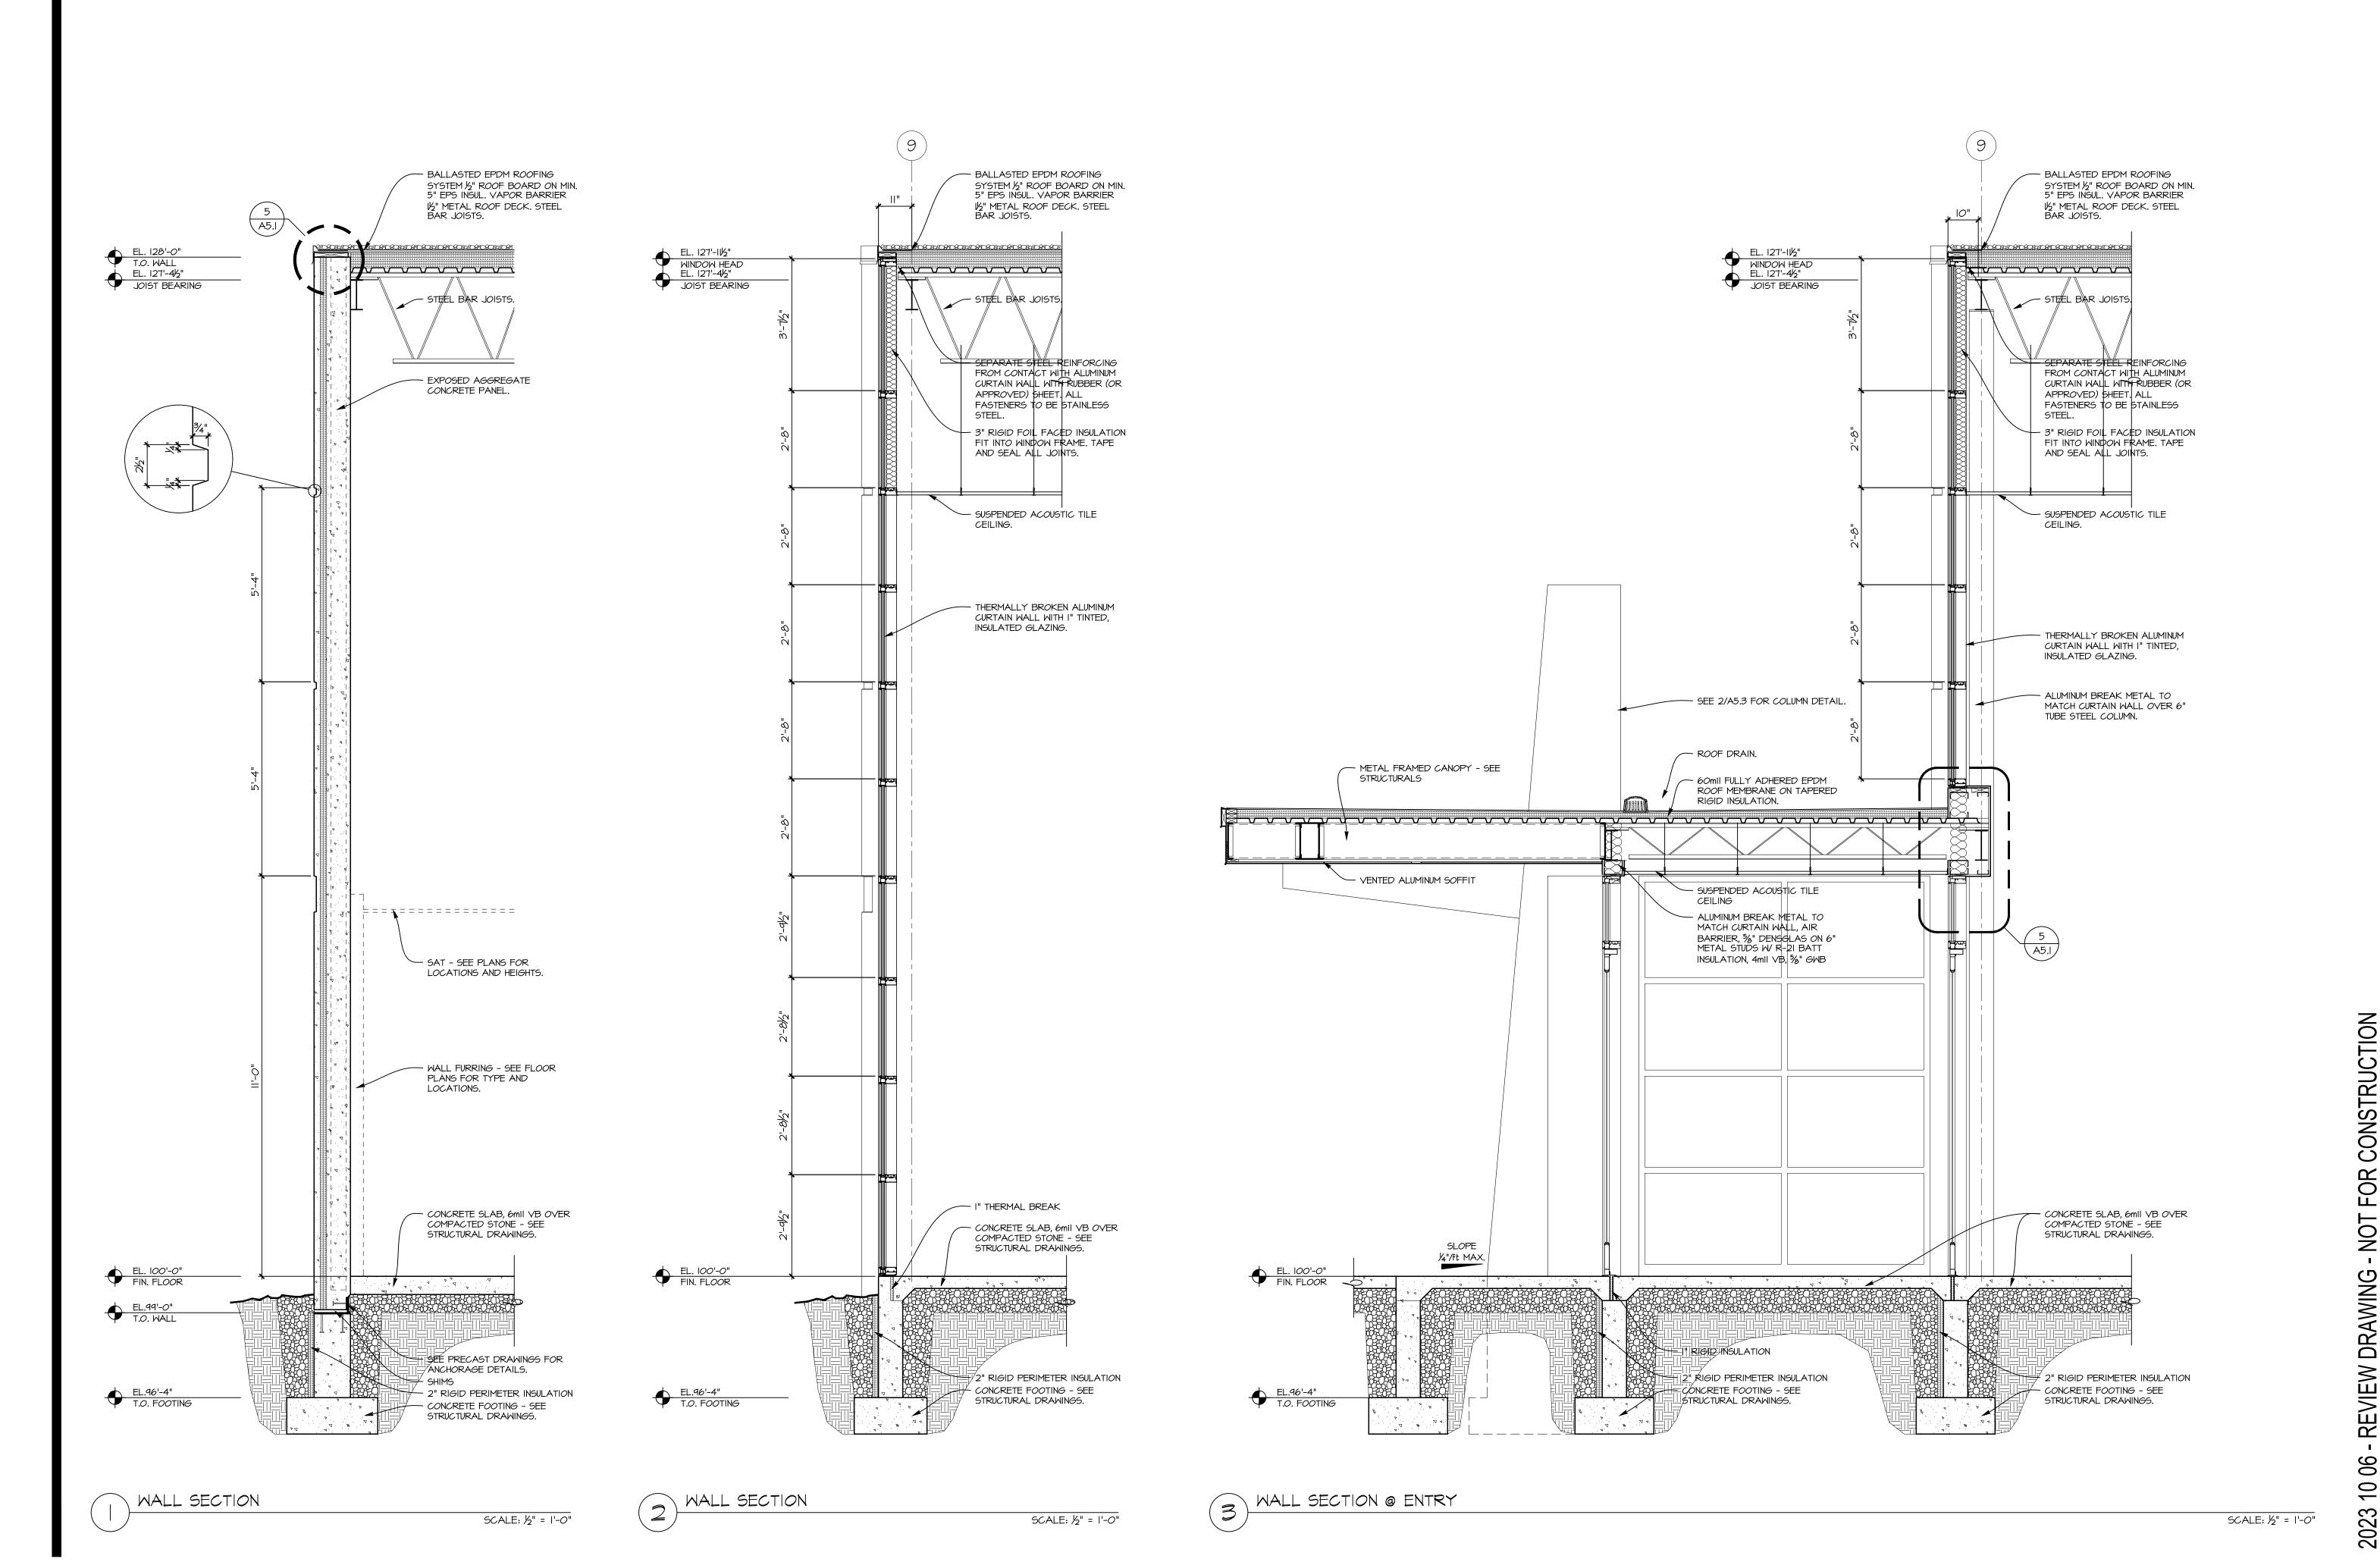

ARCHITECTURE + ENGINEERING

4040 N. Calhoun Road Suite #200 • Brookfield, WI 53005

SOURCE (OFFICE) 262-784-101

REVISIONS:
- X

-


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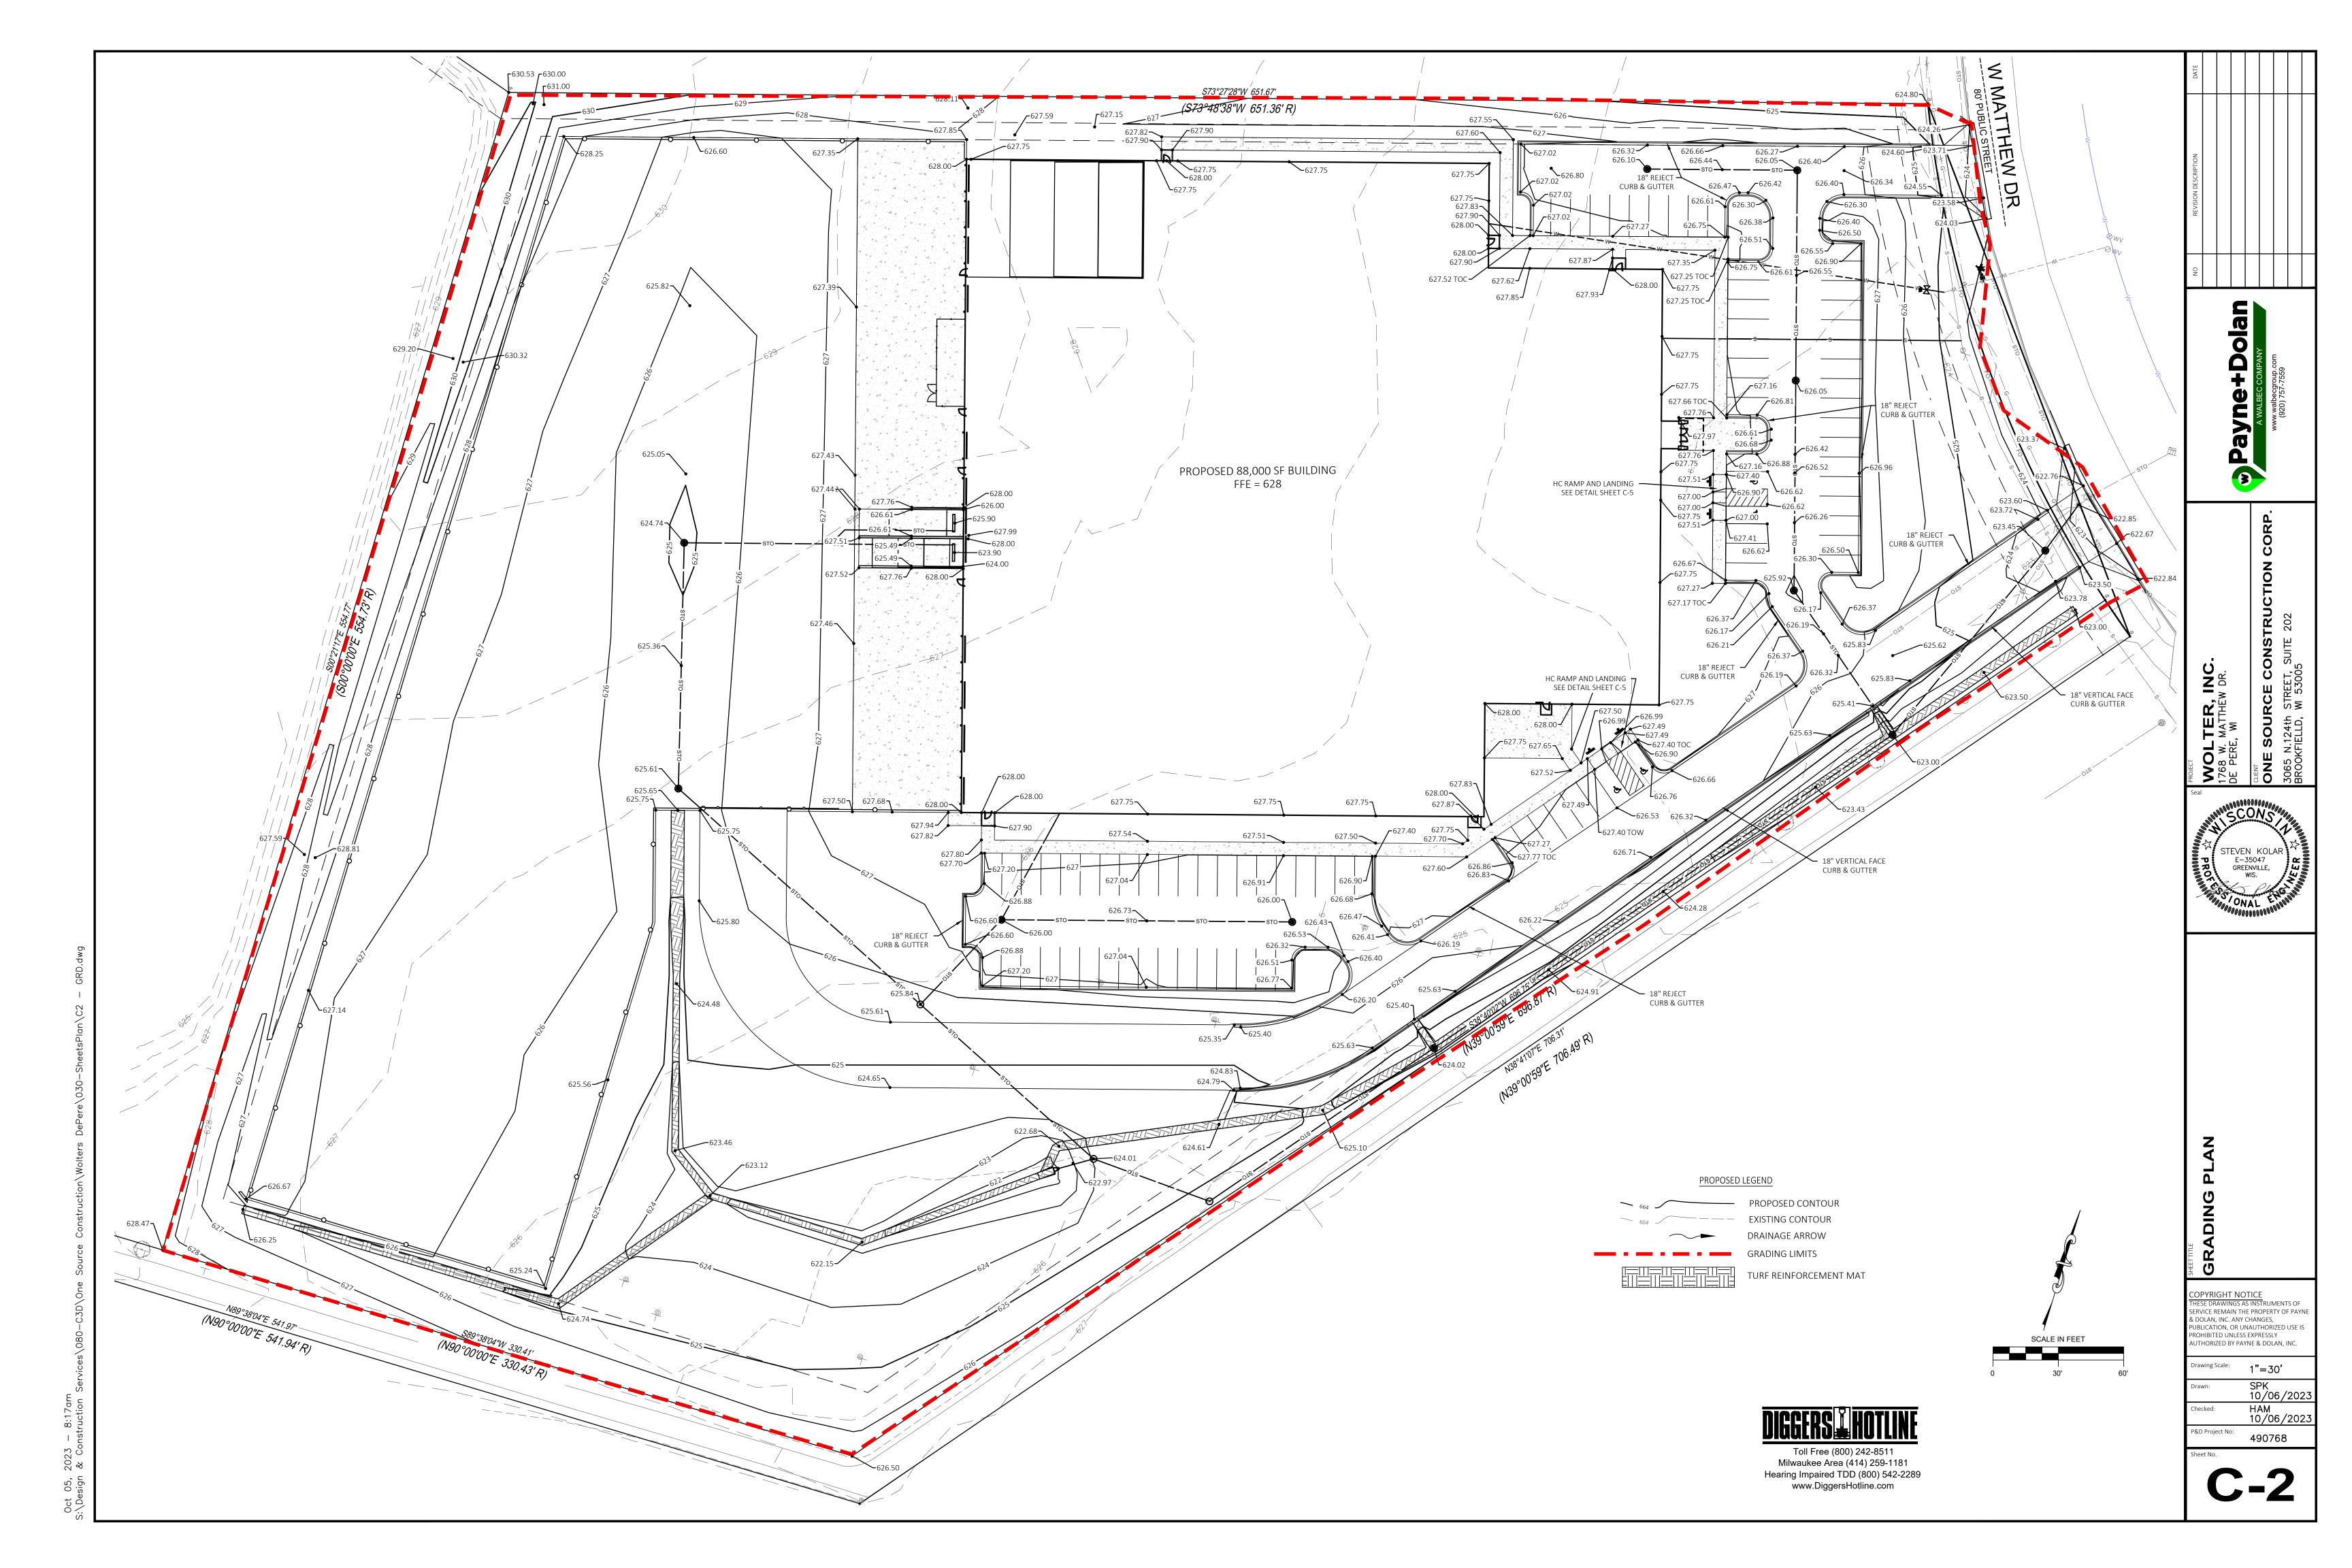
МАТТНЕМ DR.


DE PERE, WI
SHEET TITLE:

1768 v DE PEF

DATE: 10/06/2023



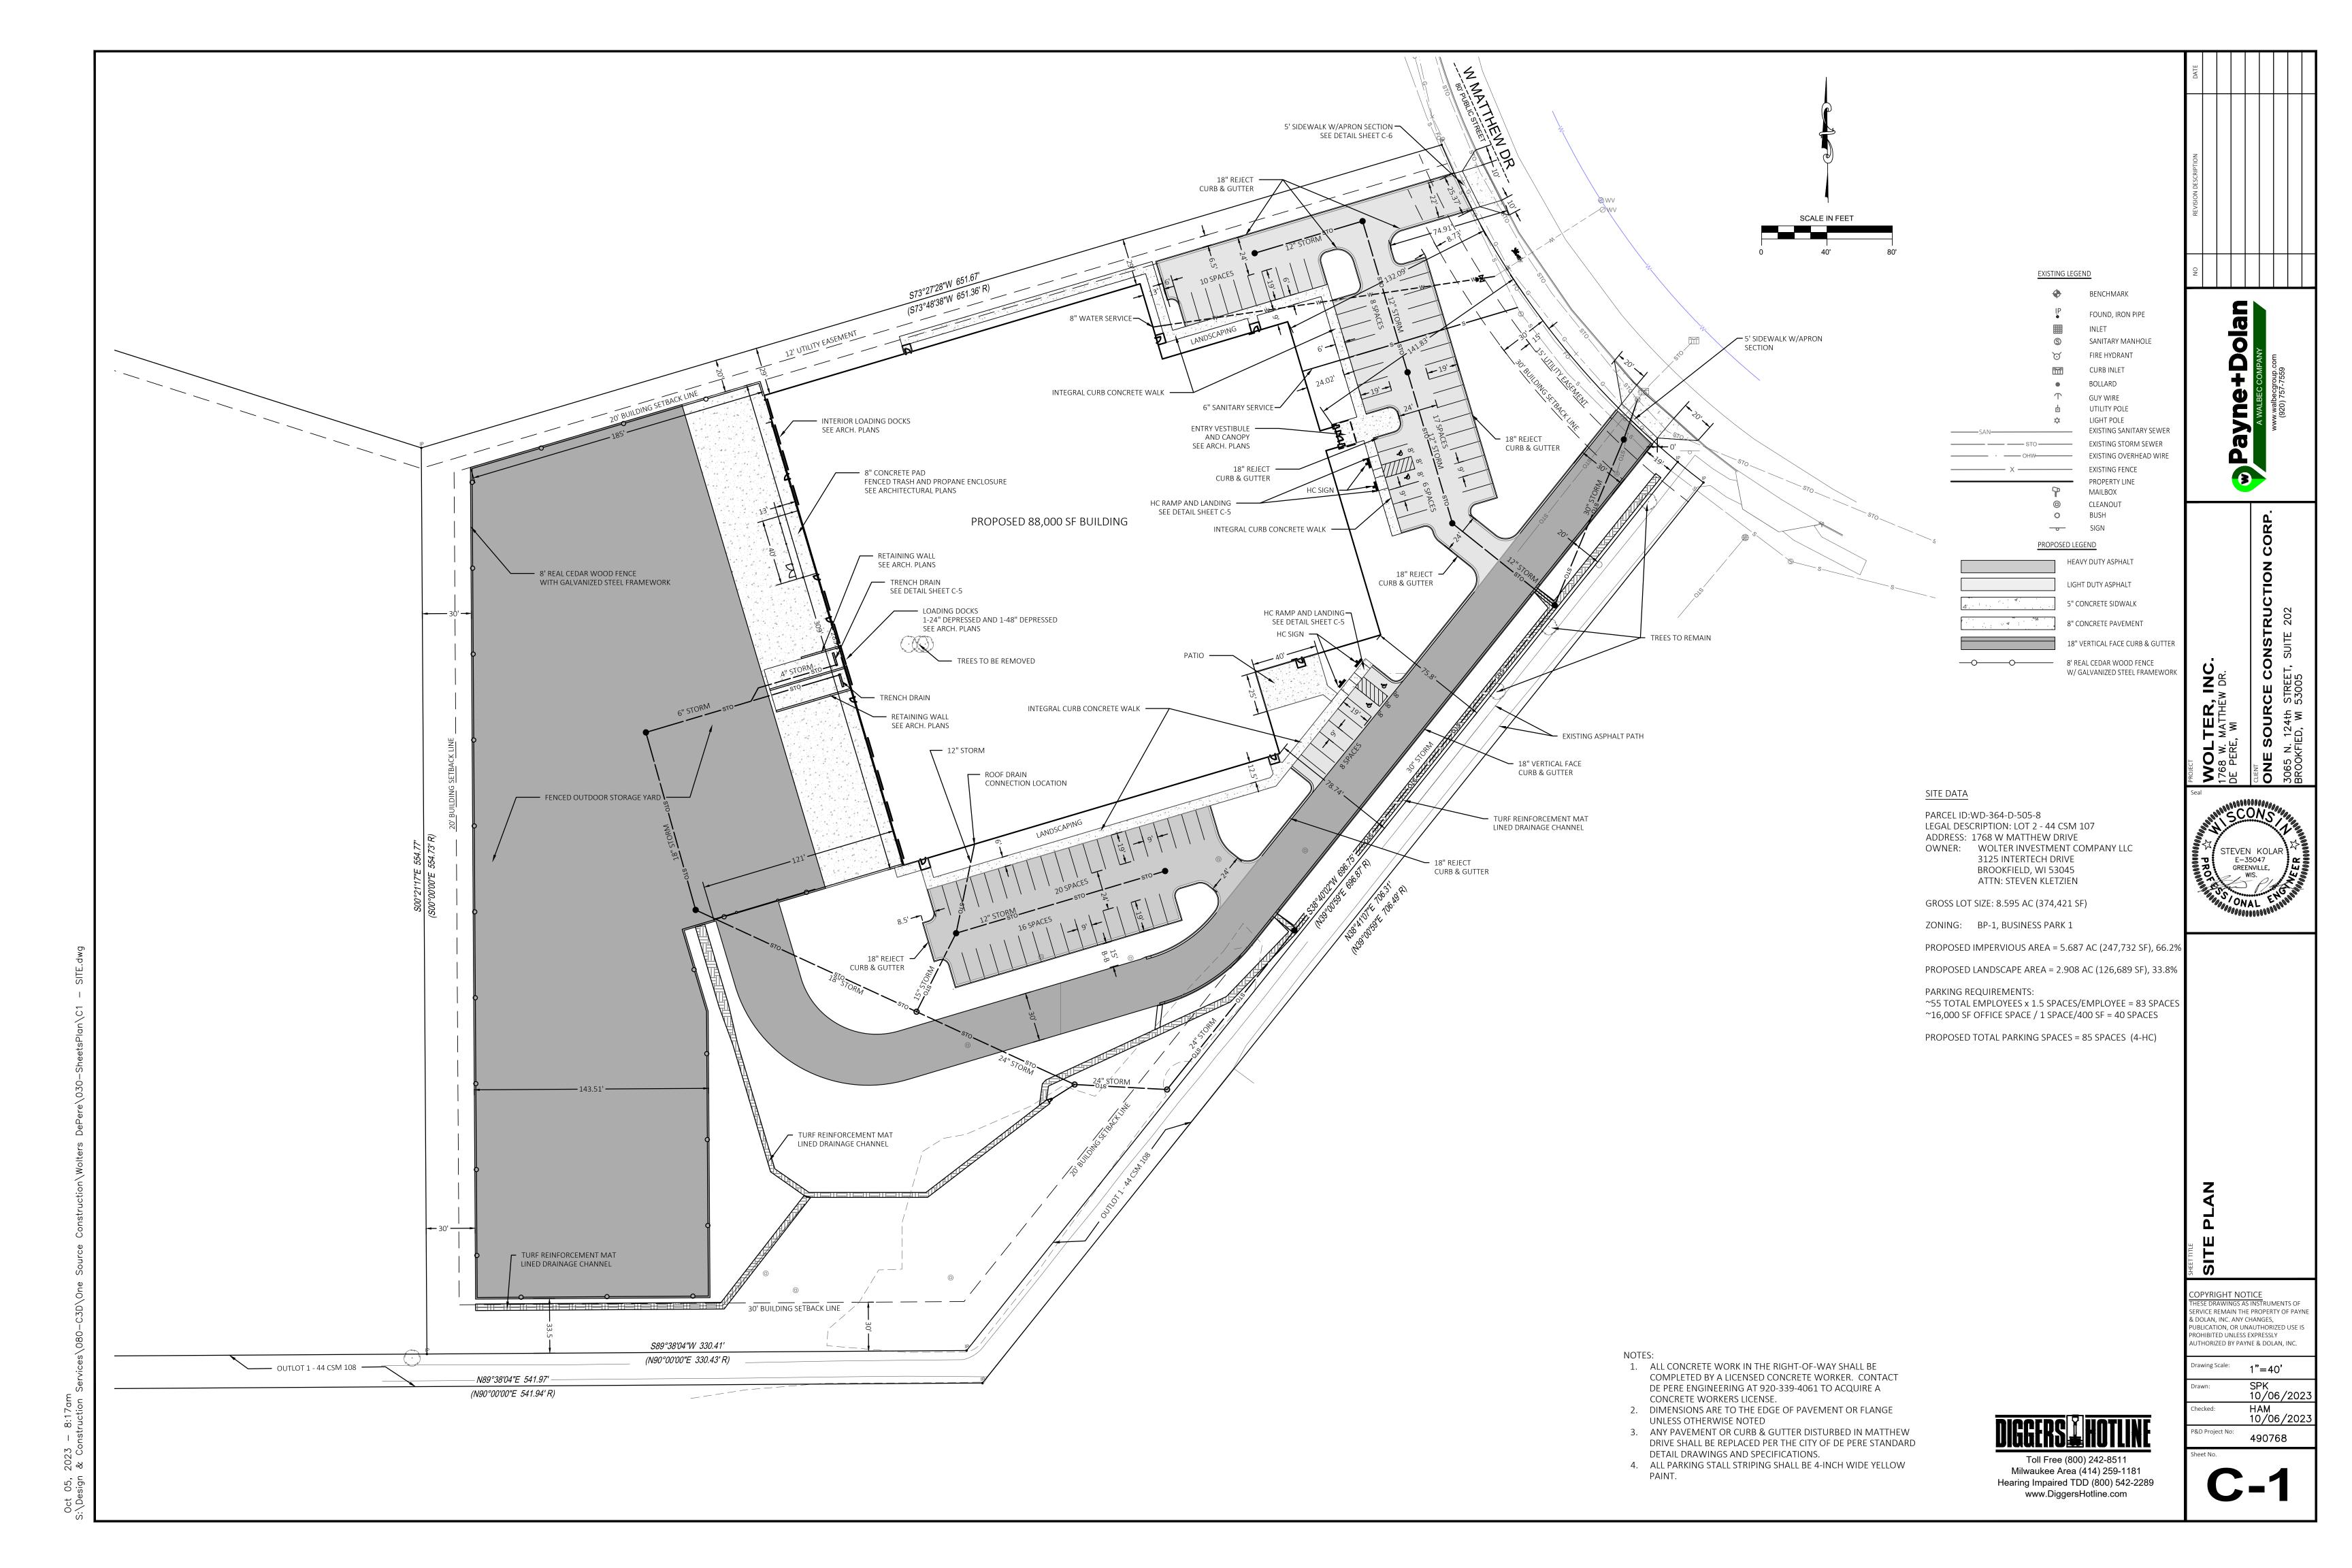

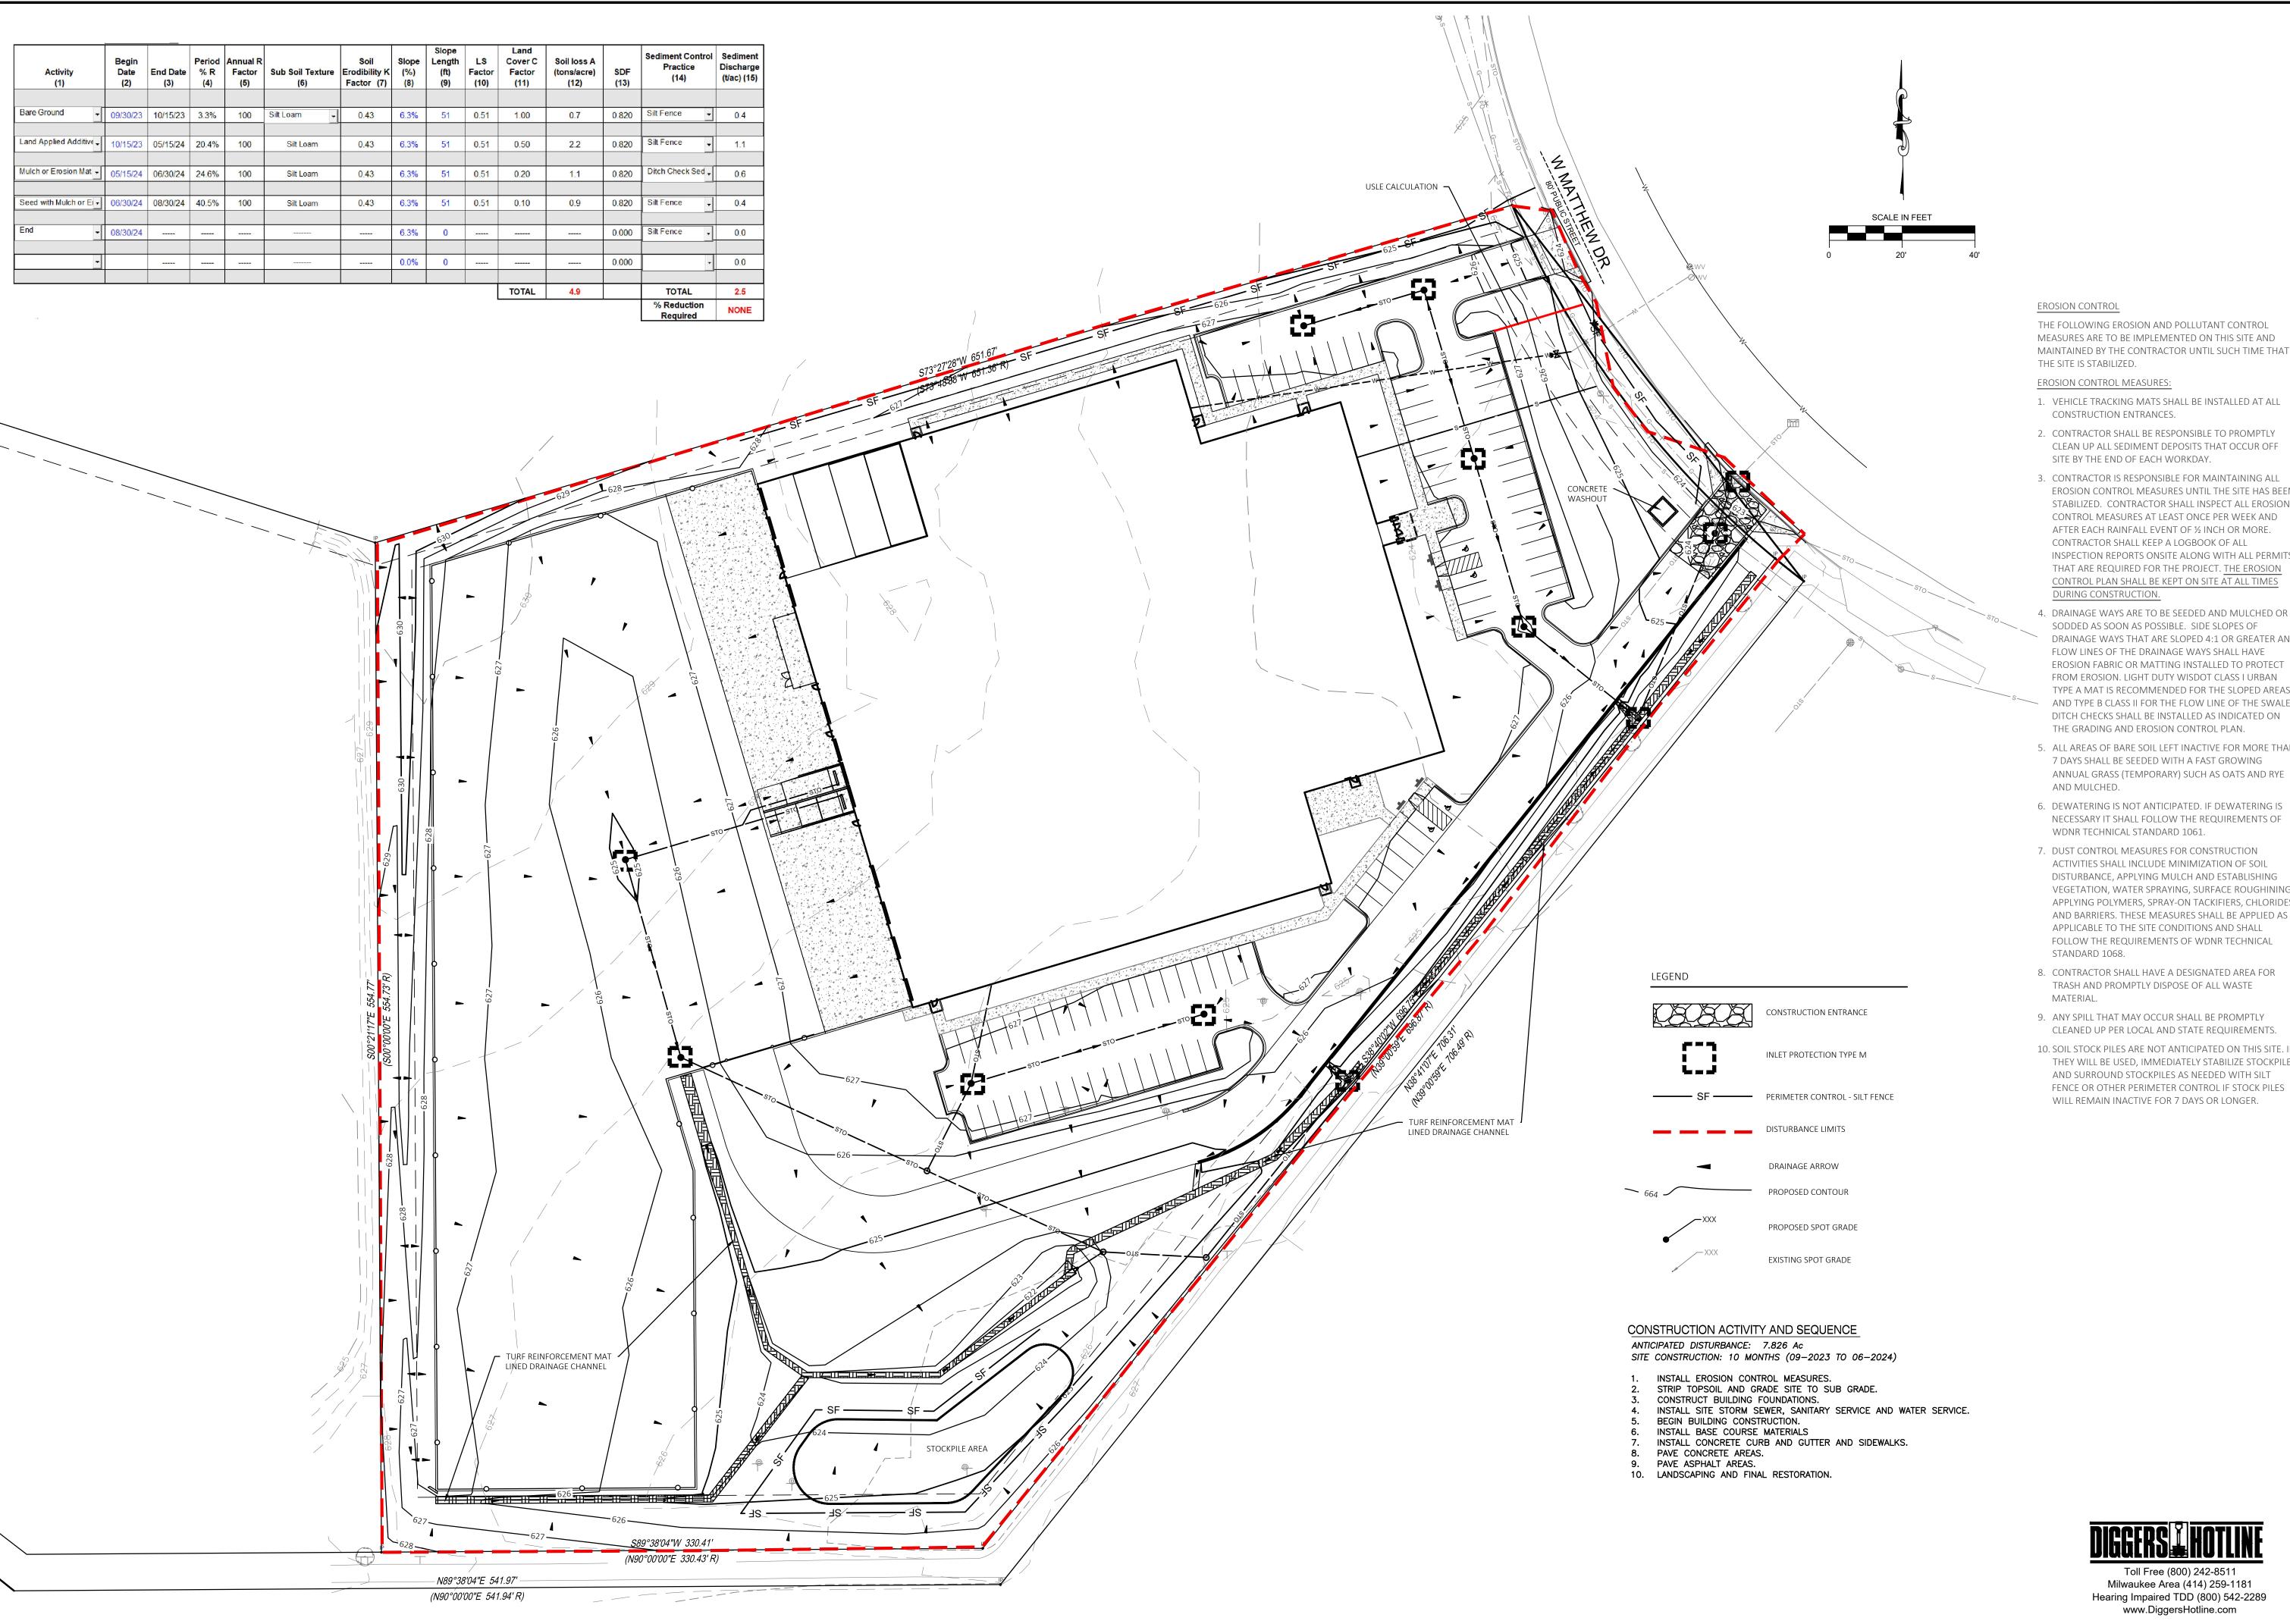

THE FOLLOWING EROSION AND POLLUTANT CONTROL MEASURES ARE TO BE IMPLEMENTED ON THIS SITE AND MAINTAINED BY THE CONTRACTOR UNTIL SUCH TIME THAT

- 1. VEHICLE TRACKING MATS SHALL BE INSTALLED AT ALL
- 2. CONTRACTOR SHALL BE RESPONSIBLE TO PROMPTLY CLEAN UP ALL SEDIMENT DEPOSITS THAT OCCUR OFF
- 3. CONTRACTOR IS RESPONSIBLE FOR MAINTAINING ALL EROSION CONTROL MEASURES UNTIL THE SITE HAS BEEN STABILIZED. CONTRACTOR SHALL INSPECT ALL EROSION CONTROL MEASURES AT LEAST ONCE PER WEEK AND AFTER EACH RAINFALL EVENT OF ½ INCH OR MORE. CONTRACTOR SHALL KEEP A LOGBOOK OF ALL INSPECTION REPORTS ONSITE ALONG WITH ALL PERMITS THAT ARE REQUIRED FOR THE PROJECT. THE EROSION CONTROL PLAN SHALL BE KEPT ON SITE AT ALL TIMES
- SODDED AS SOON AS POSSIBLE. SIDE SLOPES OF DRAINAGE WAYS THAT ARE SLOPED 4:1 OR GREATER AND FLOW LINES OF THE DRAINAGE WAYS SHALL HAVE EROSION FABRIC OR MATTING INSTALLED TO PROTECT FROM EROSION. LIGHT DUTY WISDOT CLASS I URBAN TYPE A MAT IS RECOMMENDED FOR THE SLOPED AREAS AND TYPE B CLASS II FOR THE FLOW LINE OF THE SWALE DITCH CHECKS SHALL BE INSTALLED AS INDICATED ON THE GRADING AND EROSION CONTROL PLAN.
- 5. ALL AREAS OF BARE SOIL LEFT INACTIVE FOR MORE THAI 7 DAYS SHALL BE SEEDED WITH A FAST GROWING ANNUAL GRASS (TEMPORARY) SUCH AS OATS AND RYE
- 6. DEWATERING IS NOT ANTICIPATED. IF DEWATERING IS NECESSARY IT SHALL FOLLOW THE REQUIREMENTS OF WDNR TECHNICAL STANDARD 1061.
- 7. DUST CONTROL MEASURES FOR CONSTRUCTION ACTIVITIES SHALL INCLUDE MINIMIZATION OF SOIL DISTURBANCE, APPLYING MULCH AND ESTABLISHING VEGETATION, WATER SPRAYING, SURFACE ROUGHINING APPLYING POLYMERS, SPRAY-ON TACKIFIERS, CHLORIDES AND BARRIERS. THESE MEASURES SHALL BE APPLIED AS APPLICABLE TO THE SITE CONDITIONS AND SHALL FOLLOW THE REQUIREMENTS OF WDNR TECHNICAL
- 8. CONTRACTOR SHALL HAVE A DESIGNATED AREA FOR TRASH AND PROMPTLY DISPOSE OF ALL WASTE
- 9. ANY SPILL THAT MAY OCCUR SHALL BE PROMPTLY CLEANED UP PER LOCAL AND STATE REQUIREMENTS.
- 10. SOIL STOCK PILES ARE NOT ANTICIPATED ON THIS SITE. II THEY WILL BE USED, IMMEDIATELY STABILIZE STOCKPILE AND SURROUND STOCKPILES AS NEEDED WITH SILT FENCE OR OTHER PERIMETER CONTROL IF STOCK PILES WILL REMAIN INACTIVE FOR 7 DAYS OR LONGER.


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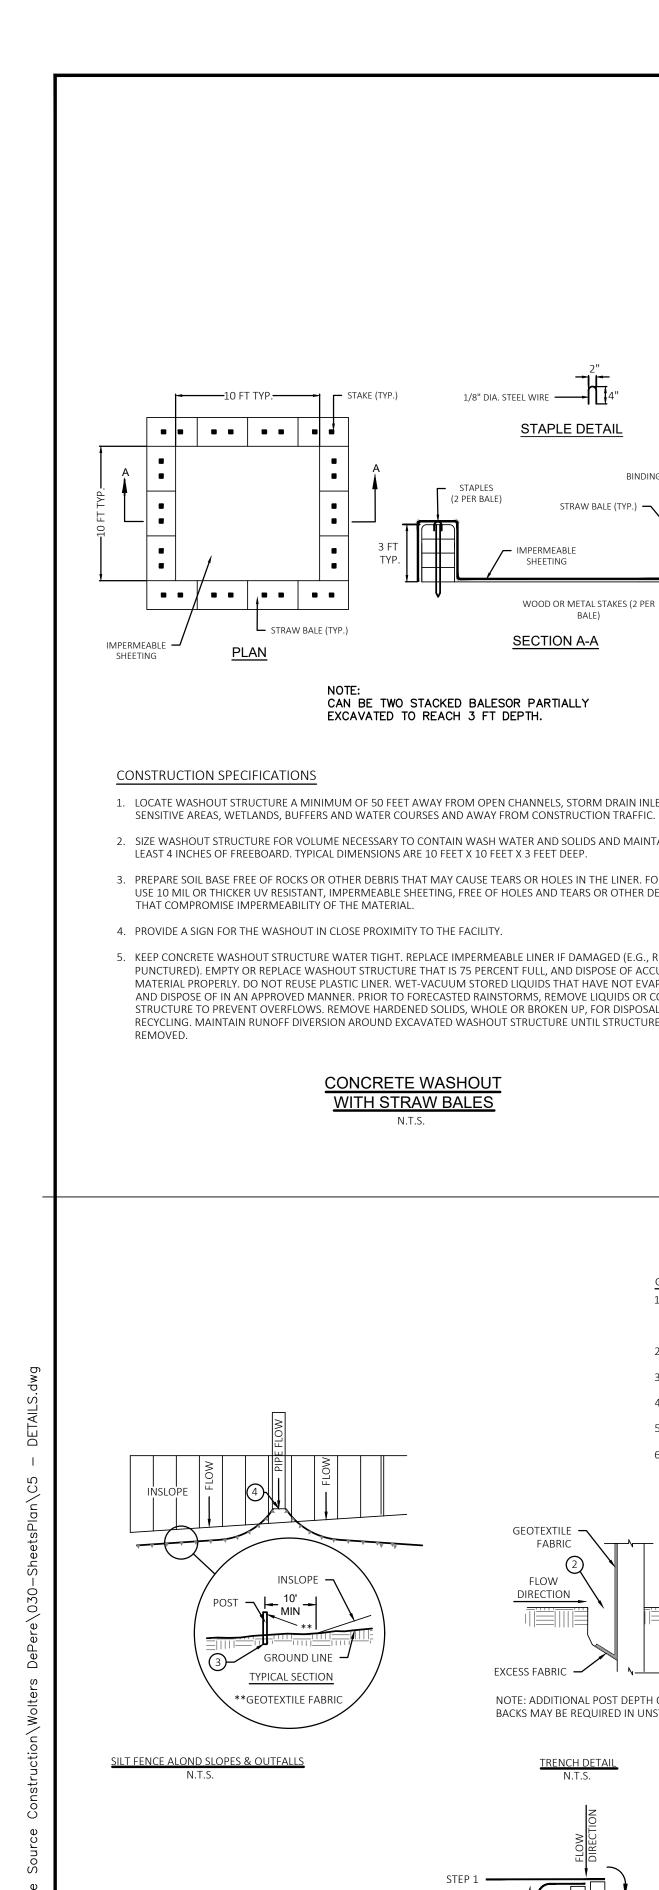
STEVEN KOLAR


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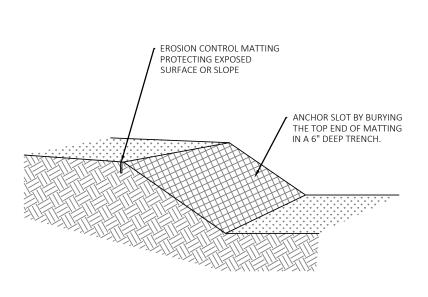


- 1. LOCATE WASHOUT STRUCTURE A MINIMUM OF 50 FEET AWAY FROM OPEN CHANNELS, STORM DRAIN INLETS,
- 2. SIZE WASHOUT STRUCTURE FOR VOLUME NECESSARY TO CONTAIN WASH WATER AND SOLIDS AND MAINTAIN AT
- 3. PREPARE SOIL BASE FREE OF ROCKS OR OTHER DEBRIS THAT MAY CAUSE TEARS OR HOLES IN THE LINER. FOR LINER, USE 10 MIL OR THICKER UV RESISTANT, IMPERMEABLE SHEETING, FREE OF HOLES AND TEARS OR OTHER DEFECTS
- 4. PROVIDE A SIGN FOR THE WASHOUT IN CLOSE PROXIMITY TO THE FACILITY.
- 5. KEEP CONCRETE WASHOUT STRUCTURE WATER TIGHT. REPLACE IMPERMEABLE LINER IF DAMAGED (E.G., RIPPED OR PUNCTURED). EMPTY OR REPLACE WASHOUT STRUCTURE THAT IS 75 PERCENT FULL, AND DISPOSE OF ACCUMULATED MATERIAL PROPERLY. DO NOT REUSE PLASTIC LINER. WET-VACUUM STORED LIQUIDS THAT HAVE NOT EVAPORATED AND DISPOSE OF IN AN APPROVED MANNER. PRIOR TO FORECASTED RAINSTORMS, REMOVE LIQUIDS OR COVER STRUCTURE TO PREVENT OVERFLOWS. REMOVE HARDENED SOLIDS, WHOLE OR BROKEN UP, FOR DISPOSAL OR RECYCLING. MAINTAIN RUNOFF DIVERSION AROUND EXCAVATED WASHOUT STRUCTURE UNTIL STRUCTURE IS

WITH STRAW BALES N.T.S.

1. PRIOR TO THE INSTALLATION OF ANY EROSION CONTROL MATTING, ALL ROCKS, DIRT CLODS, STUMPS, ROOTS, TRASH AND ANY OTHER OBSTRUCTIONS WHICH WOULD PREVENT THE MAT FROM LAYING IN DIRECT CONTACT WITH THE SOIL SHALL BE REMOVED.

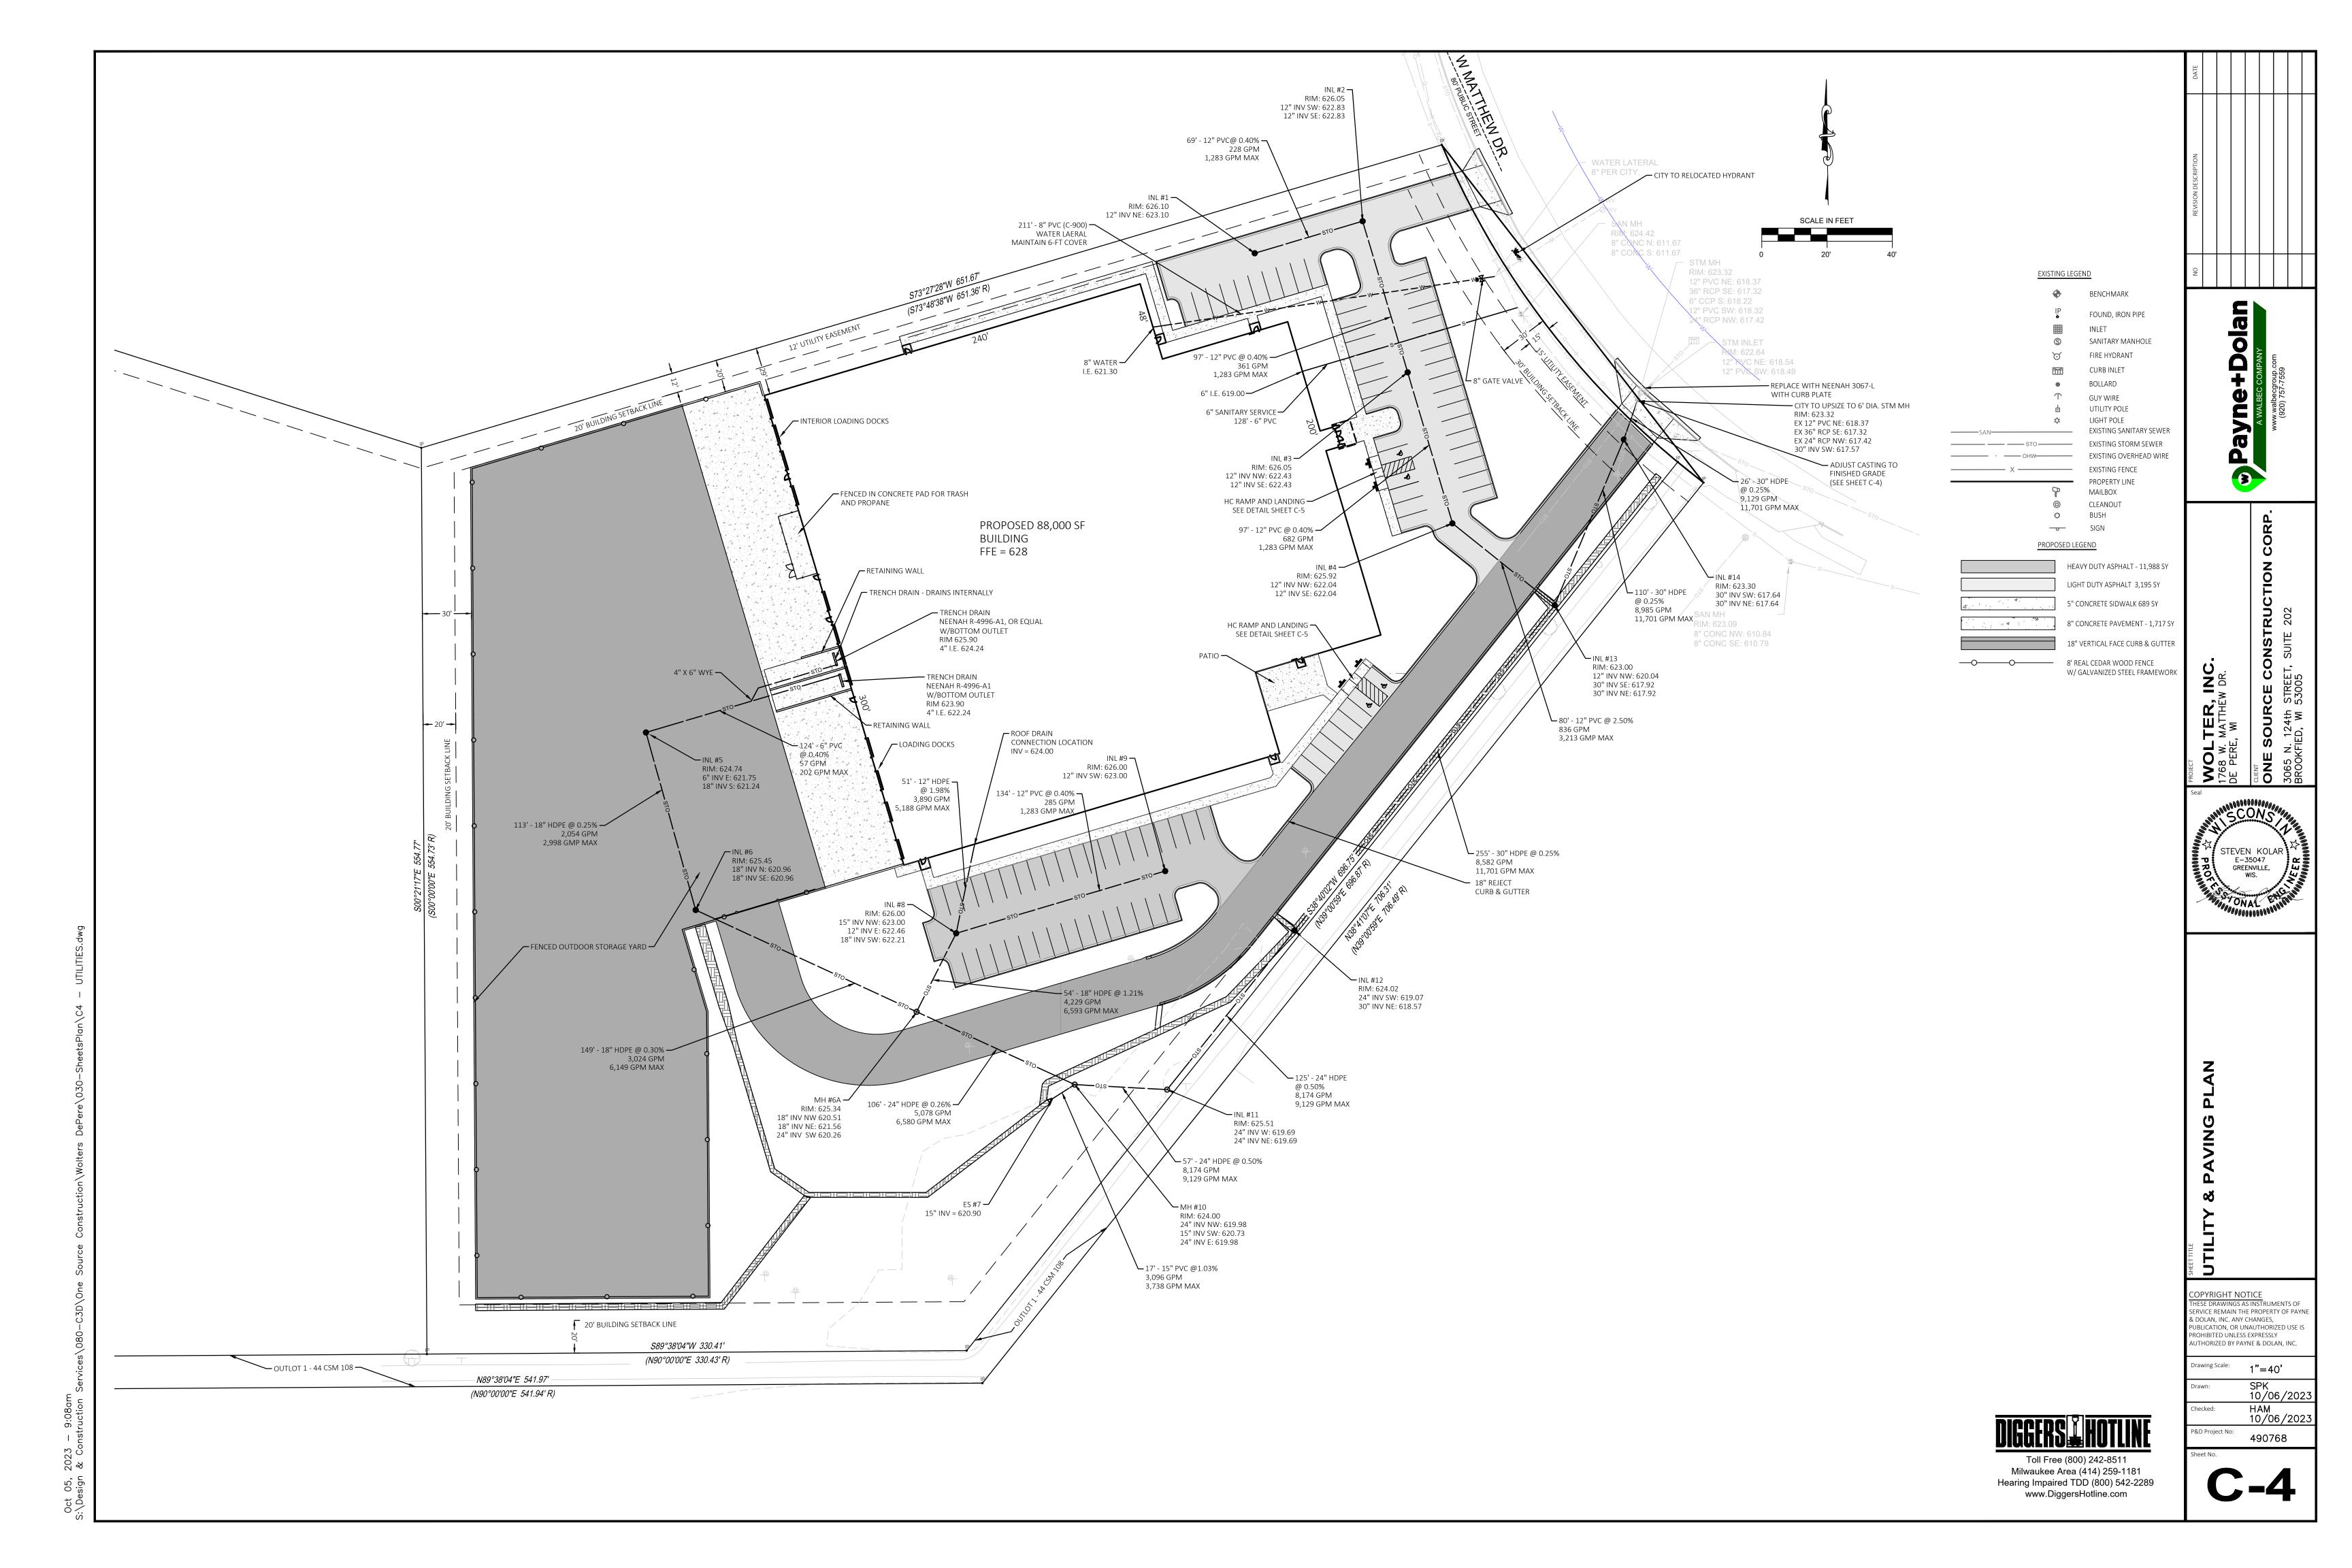- 2. THE MATTING SHALL BE ANCHORED ALONG ITS ENTIRE PERIMETER WITH A 6"x6" ANCHOR TRENCH. AFTER MATTING IS LAID IN TRENCH, BACKFILL, AND COMPACT WITH SOIL OR GRAVEL.
- 3. THE MATTING SHALL BE ANCHORED TO THE GROUND USING 10 GAUGE WIRE STAPLES, 6" IN LENGTH BY 1" WIDE WITH A COVERAGE NOT LESS THAN 1 STAPLE PER EVERY 4 SQUARE FEET OF MATTING.
- 4. INSTALLATIONS SHALL ALSO BE IN ACCORDANCE WITH MANUFACTURERS RECOMMENDED
- GUIDELINES. 5. EROSION CONTROL MATTING SHALL BE ONE OF THE FOLLOWING: A. JUTE MAT COMPOSED OF A JUTE YARN WEAVED IN A BASIC MANNER AND FREE OF
- ANY DYE AND HAVING A MINIMUM UNIT WEIGHT OF 2.7 LBS. PER SQ. YARD. B. WOOD FIBER MAT COMPOSED OF WOOD FIBERS ENCASED IN A NETTING MADE OF NYLON, COTTON OR SIMILAR MATERIAL AND HAVING A MINIMUM UNIT WEIGHT OF 1.0 LBS. PER SQ. YARD.
- C. SYNTHETIC WEBBING MAT MADE OF POLYVINYL CHLORIDE POLYPROPYLENE MONOFILIMENTS HAVING A MINIMUM UNIT WEIGHT OF 11 OUNCES PER SQ. YARD AND AMINIMUM TENSILE STRENGTH OF 25 LBS. IN ALL DIRECTIONS. (ASTM D-1682.64)
- 6. MATTED AREAS MUST BE INSPECTED ON A WEEKLY BASIS, AND AFTER EACH SIGNIFICANT RAINFALL. BARE SPOTS, MISSING OR LOOSENED MATTING MUST BE IMMEDIATELY REPLACED AND/OR
- 7. STAPLES SHALL BE REMOVED FROM THE GROUND ONCE THE THREAT OF EROSION HAS PASSED AND PERMANENT VEGETATION HAS BEEN ESTABLISHED.

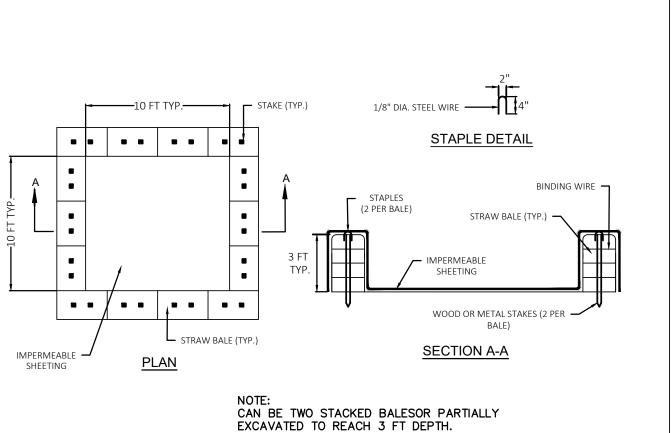


SEAM -

LEAST 3 PLACES


WOOD POST (TYP.)

AVOID PLACING DRAINAGE STRUCTURES, JUNCTION BOXES OR OTHER OBSTRUCTIONS IN FRONT OF RAMP ACCESS AREAS.

- SIDEWALK CROSS SLOPE SHALL NOT EXCEED 2%. DETECTABLE WARNING FIELDS THAT ARE INSTALLED AS A GROUP OR SIDE BY SIDE, SHALL BE FROM THE SAME MANUFACTURER.
- 1. PROVIDE A LEVEL LANDING (MAXIMUM 2% SLOPE) IN ANY DIRECTION OF PEDESTRIAN TRAVEL. STANDARD LANDING SIZE IS 5FT X 5FT. 2. SLOPE SIDEWALK TOWARD LANDING AS SHOWN WHERE THERE IS NO TERRACE OR WHERE THE TERRACE WIDTH IS LESS THAN 6FT WIDE.
- \*DETECTABLE WARNING SURFACE. SURFACE TO BE TRUNCATED DOMES WITH A BASE DIAMETER OF 0.9" MIN. TO 1.4" MAX. AND A TOP DIAMETER OF 50% MIN. TO 65% MAX. OF THE BASE DIAMETER. HEIGHT OF DOMES SHALL HAVE A HEIGHT OF 0.2". TRUNCATED DOMES SHALL HAVE A CENTER-TO-CENTER SPACING OF 1.6" MIN. AND 2.4" MAX. AND A BASE-TO-BASE SPACING OF 0.65" MIN. MEASURED BETWEEN THE MOST ADJACENT DOMES ON THE GRID. DOMES

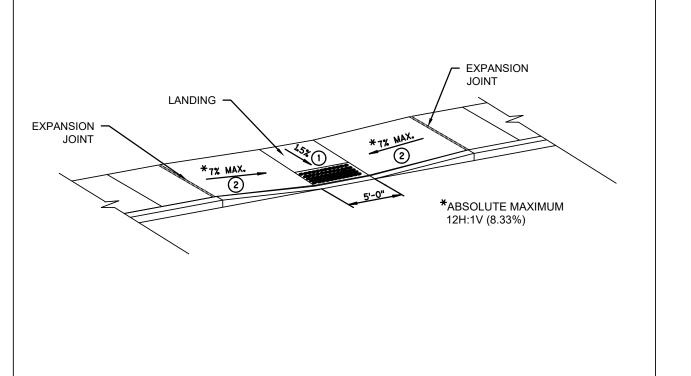

NOTE: THESE PARALLEL AND PARALLEL/PERPENDICULAR CURB RAMPS MAY BE USED AT INTERSECTIONS AND MID BLOCK LOCATIONS.

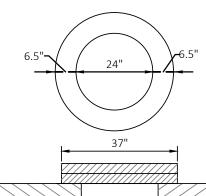

FLAT TOP SLAB


1. MANHOLE CONSTRUCTION TO MEET REQUIREMENTS OF ASTM C478.

- 2. PROVIDE FLAT TOP SLAB FOR MANHOLES 5' OR LESS IN DEPTH. FLAT TOP SLABS TO BE
- 3. JOINTS SHALL BE WATERTIGHT. USE BUTYL RUBBER GASKET.

IN-BELL TYPE.

- 4. USE RUBBER GASKETS FOR PIPE CONNECTIONS.
- 5. ECCENTRIC CONE SECTION OF MANHOLE TO BE SET OUTSIDE OF VEHICULAR WHEEL PATH NEAR & ROADWAY.

RIM ELEV.

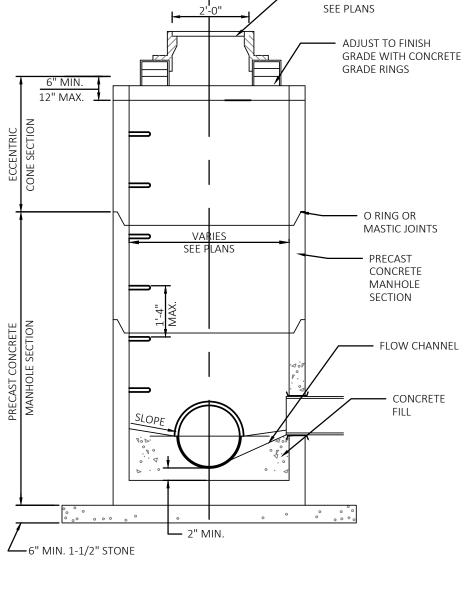

AND MULCH WHERE APPLICABLE DRAINAGE PIPE. AASHTO M252, TYP CPAND AASHTO M294, TYPE CP WITI OR APPROVED CLASS 2 PERFORATIONS (USE NON-PERFORATED PIPE FOR OUTLET PIPE) GRADE 1 GRANULAR BACKFILL PER SECTION

APPLICABLE AND REPLACE

## GENERAL NOTES

GEOTEXTILE

FLOW

EXCESS FABRIC -

NOTE: ADDITIONAL POST DEPTH OR TIE

BACKS MAY BE REQUIRED IN UNSTABLE SOILS

WOOD POST (TYP.)

FABRIC (TYP.)

- 1. SILT FENCE SHALL BE ANCHORED BY SPREADING AT LEAST 8-INCHES OF FABRIC IN A 4-INCH WIDE AND 6-INCH DEEP TRENCH OR 6-INCH DEEP V-TRENCH ON THE UPSLOPE SIDE OF THE FENCE.
- TRENCHES SHALL NOT BE EXCAVATED WIDER OR DEEPER THAN NECESSARY FOR PROPER INSTALLATION. 2. FOLD MATERIAL TO FIT TRENCH AND BACKFILL AND COMPACT TRENCH WITH EXCAVATED SOIL.
- 3. WOOD POSTS SHALL BE A MINIMUM SIZE OF 1.125-INCHES x 1.125-INCHES OF DRIED OAK OR HICKORY.
- 4. SILT FENCE TO EXTEND ABOVE THE TOP OF PIPE.
- 5. SILT FENCE CONSTRUCTION AND GEOTEXTILE FABRIC SHALL CONFORM TO WDNR TECHNICAL STANDARD 1056.
- 6. POST SPACING SHALL BE SELECTED BASED ON GEOTEXTILE FABRIC (8-FEET FOR WOVEN & 3-FEET FOR NON-WOVEN).


20" MIN. DEPTH IN


GROUND

FABRIC ONLY

SILT FENCE FABRIC SHALL BE STAPLED, USING AT LEAST -0.5-INCH STAPLES, TO THE UPSLOPE SIDE OF THE POSTS IN AT

BACKFILL & COMPACT TRENCH WITH **EXCAVATED SOIL** 

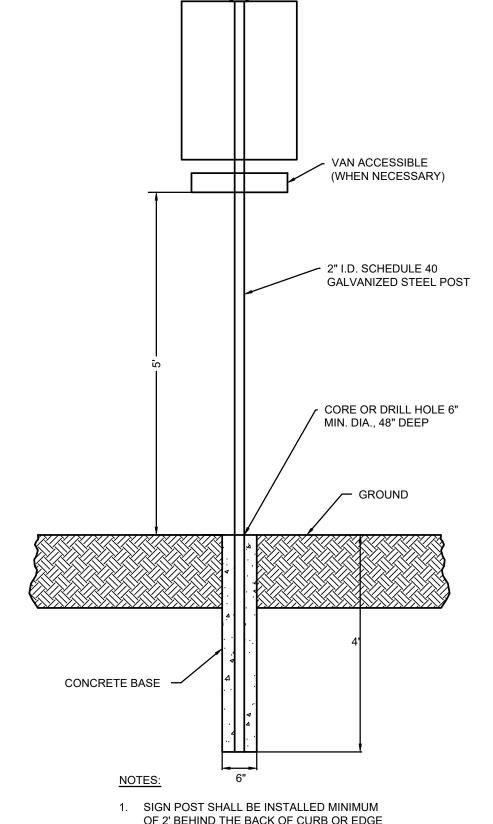

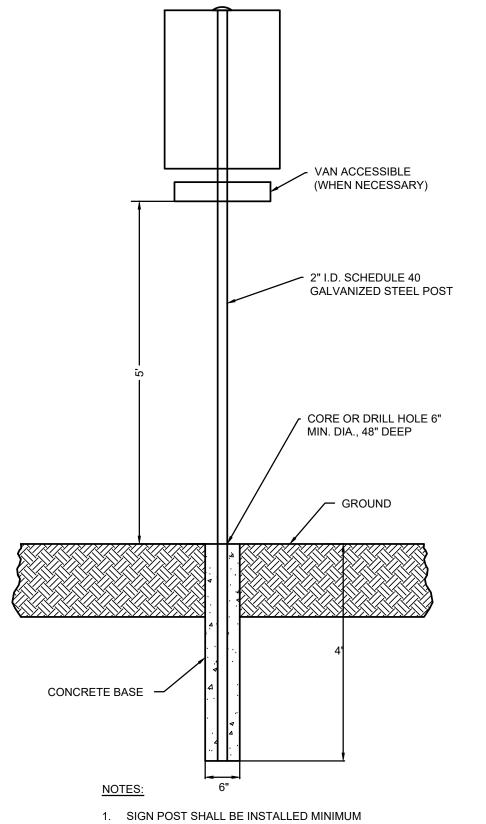


- OF 2' BEHIND THE BACK OF CURB OR EDGE OF PAVEMENT.
- 2. 7' TO THE BOTTOM OF THE LOWEST SIGN ALONG ACCESSIBLE ROUTES. 5' TO THE BOTTOM OF THE THE MAIN SIGN IN ALL OTHER LOCATIONS.

SIGN POST INSTALLATION IN LANDSCAPE AREA



PLANS BACK OF CURB —— PAVEMENT GRADE WITH COLLAR OR —— CONCRETE GRADE BOOT CONNECTION PRECAST CONCRETE 6" SUMP — OUTLET PIPE SEE PLAN DRAIN (TYP) FOR SIZE AND I.E. GRANULAR — SOIL STABILIZATION

CASTING: R-xxxx-x

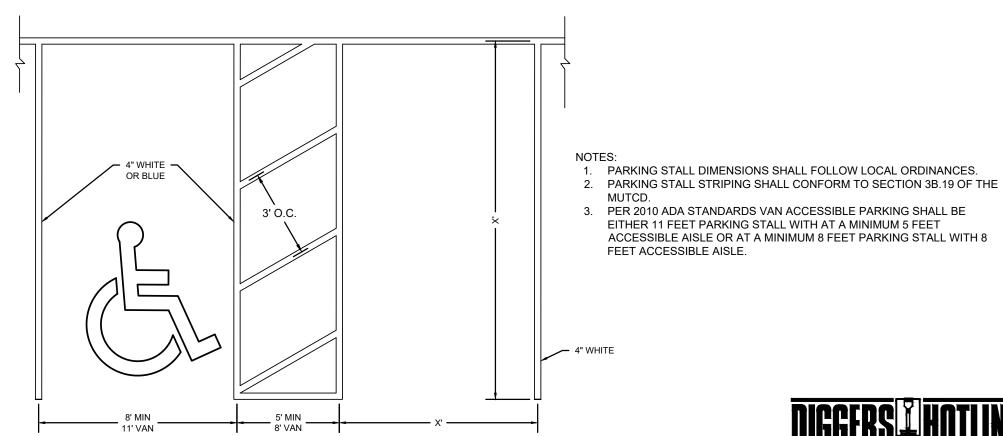

PERPENDICULAR STALL STRIPING

3. PER 2010 ADA STANDARDS VAN ACCESSIBLE PARKING SHALL BE EITHER 11 FEET PARKING STALL WITH AT A MINIMUM 5 FEET ACCESSIBLE AISLE OR AT A MINIMUM 8 FEET PARKING STALL WITH 8 FEET ACCESSIBLE AISLE.

ERVICE REMAIN THE PROPERTY OF PAYN rawing Scale:

ELEVATION REFERED

TO ON STORM SEWER


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> 10/06/2023 490768

STEVEN KOLAF



TIEBACK BETWEEN FENCE •


POST AND ANCHOR

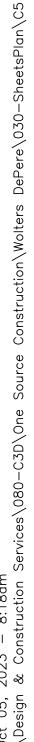
FENCE


FLOW DIRECTION ——

ANCHOR STAKE


MIN. 18" LONG

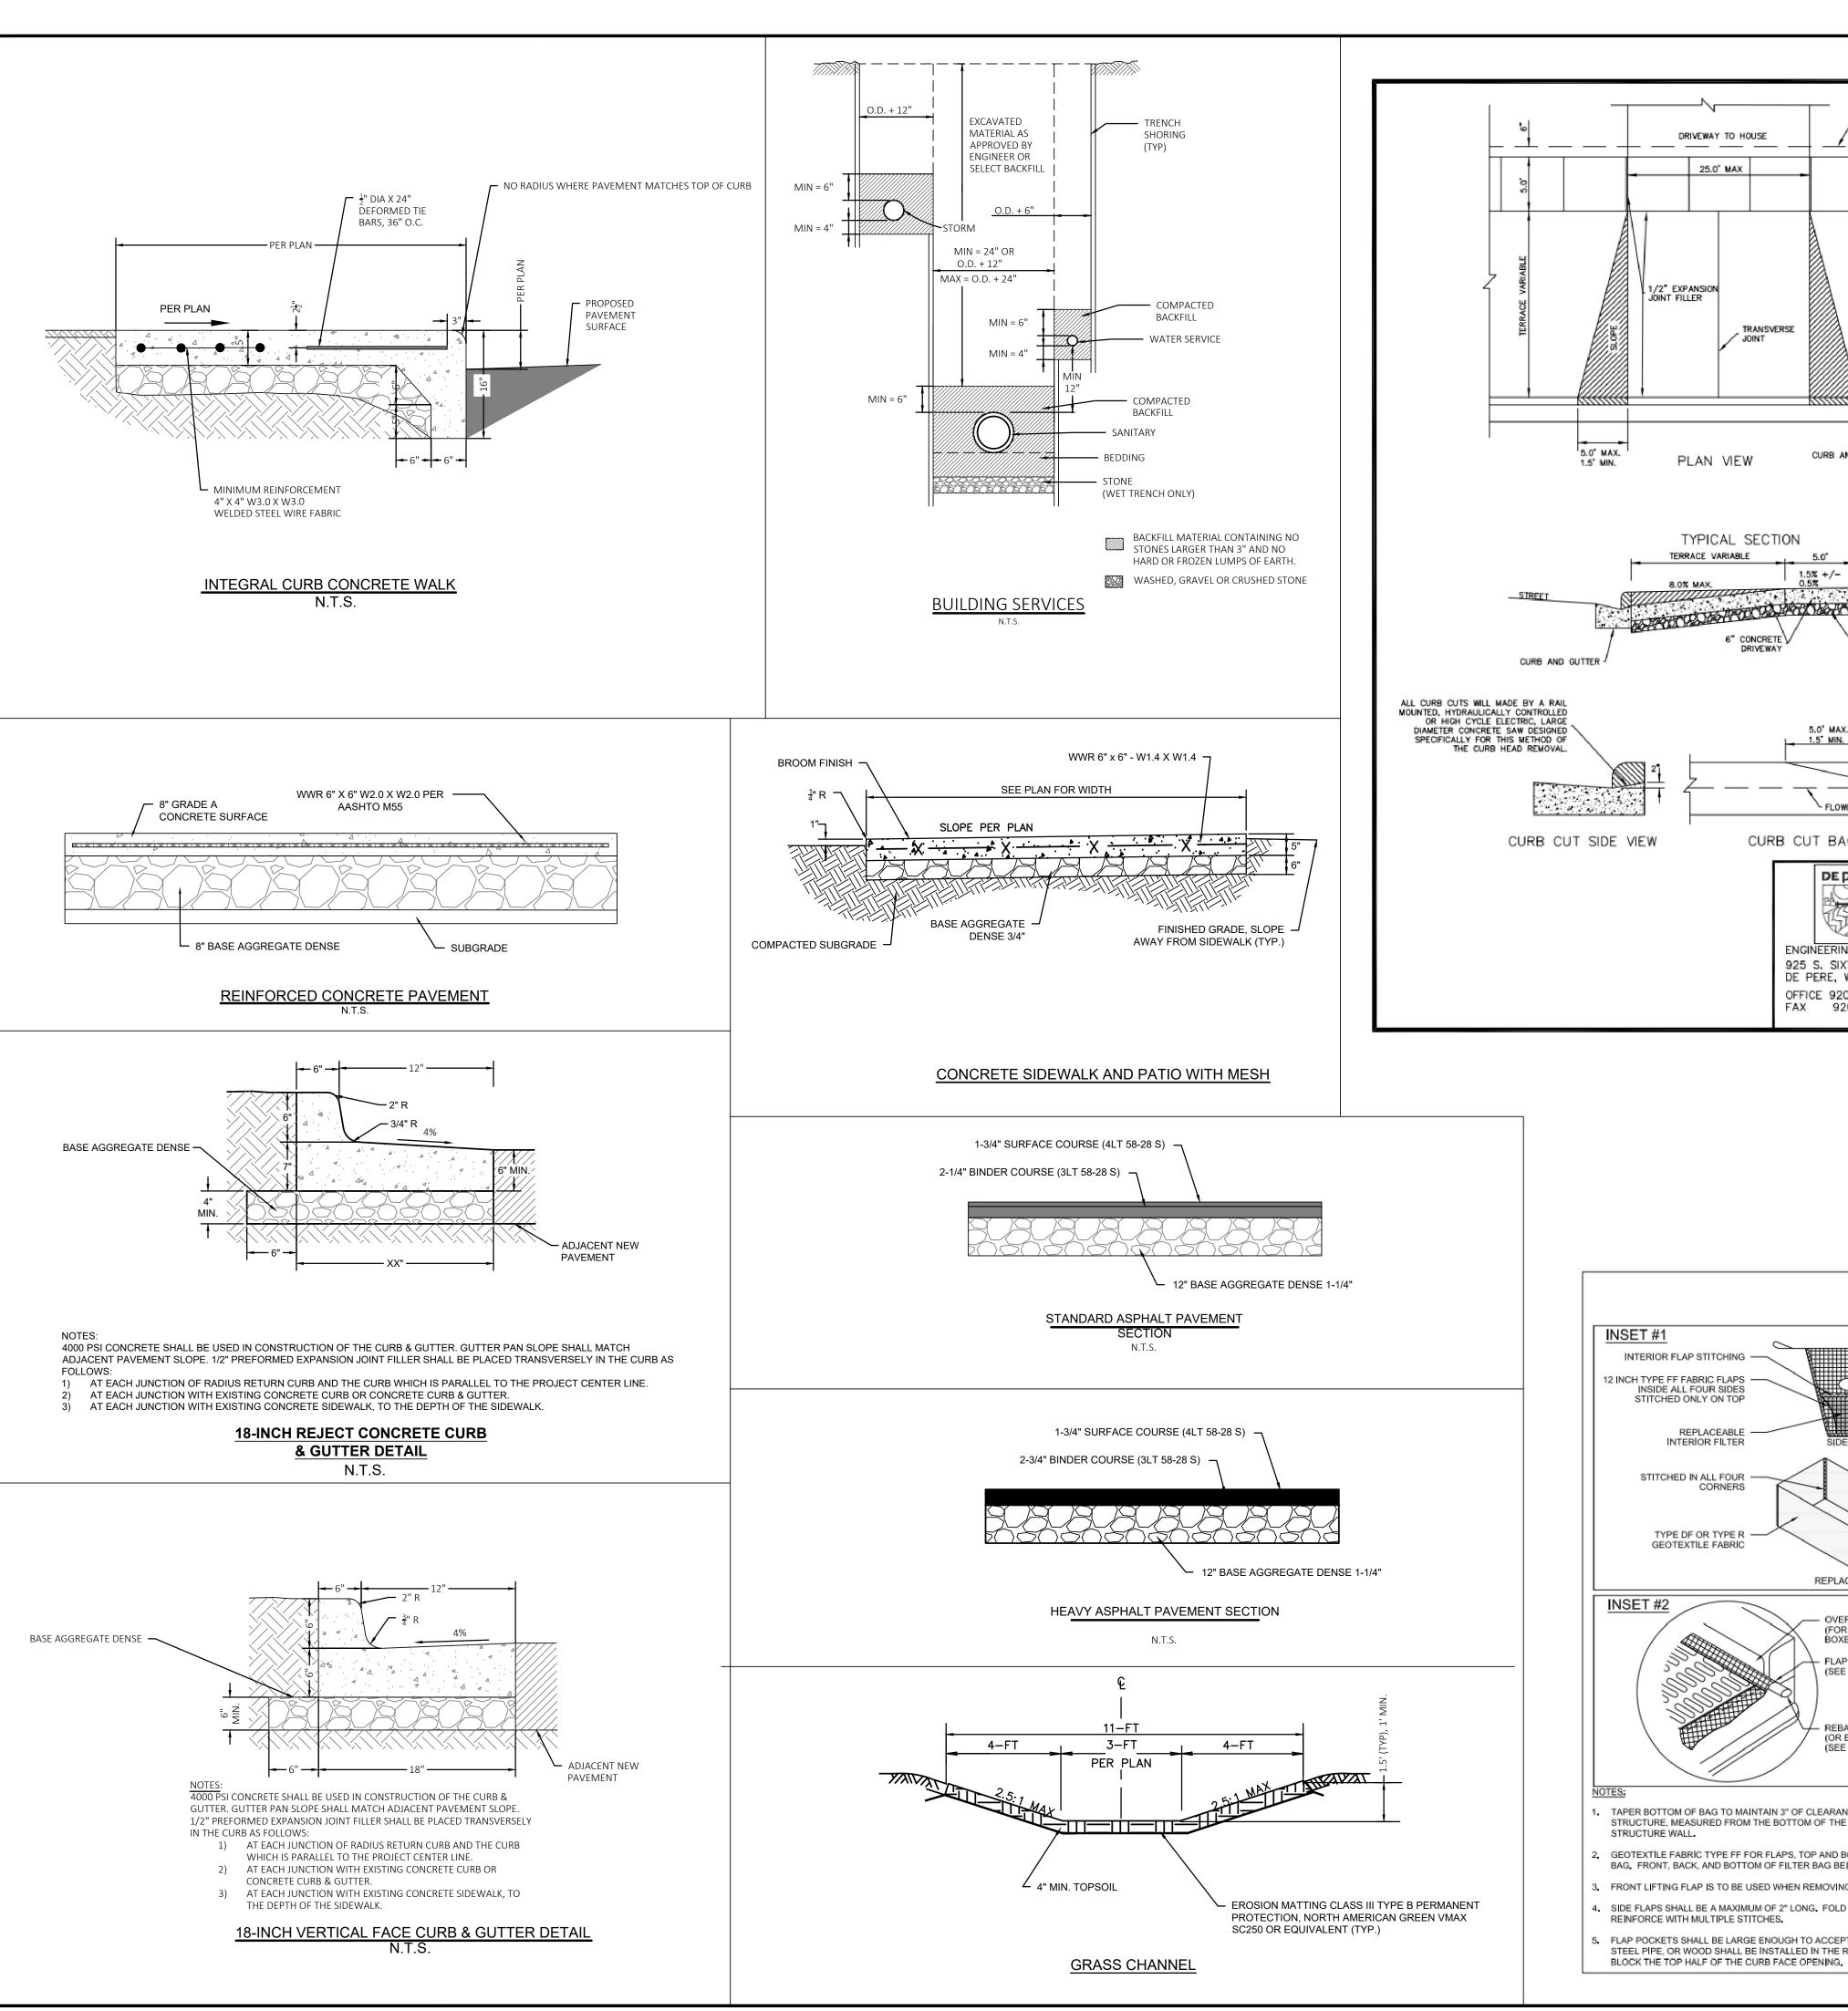

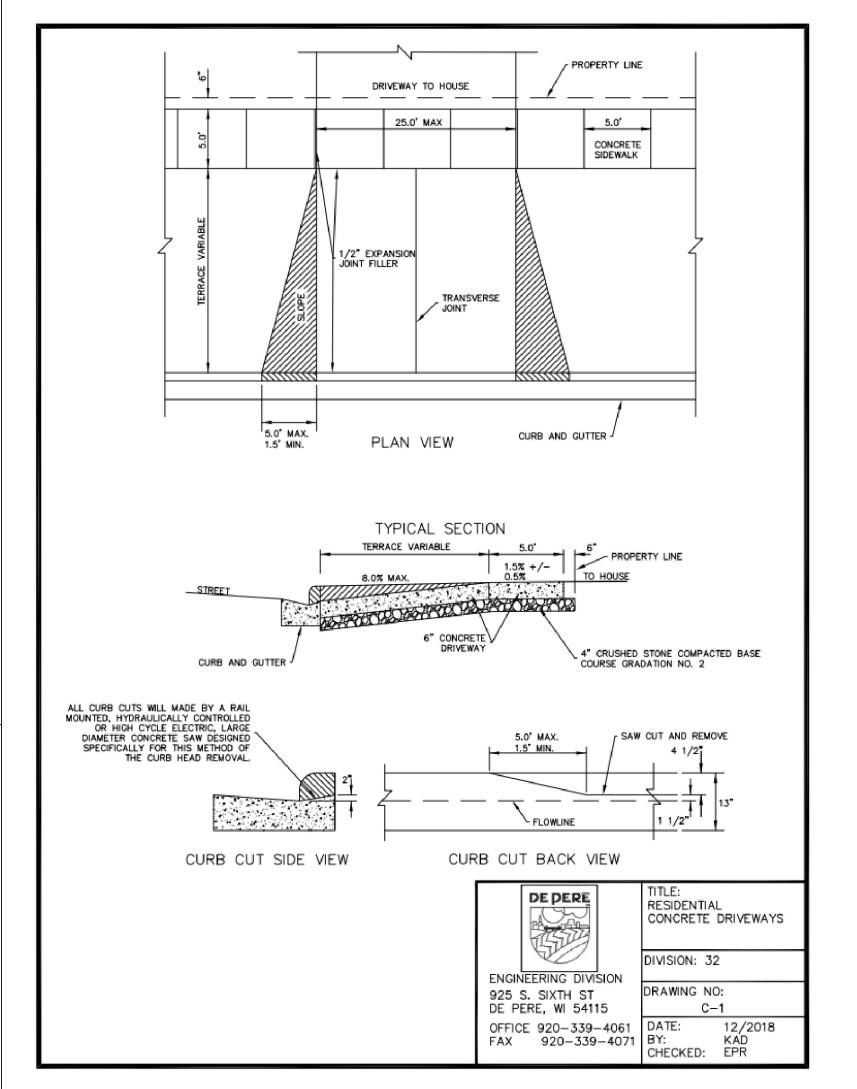

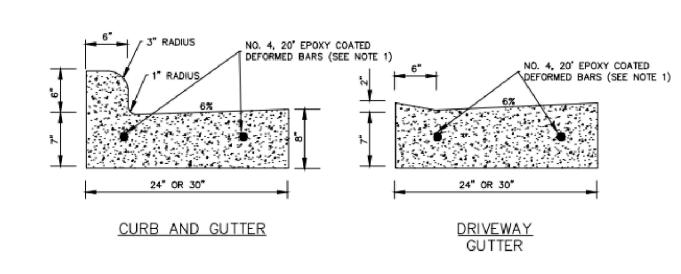


#### **CURB & GUTTER IN MATTHEWS DRIVE**

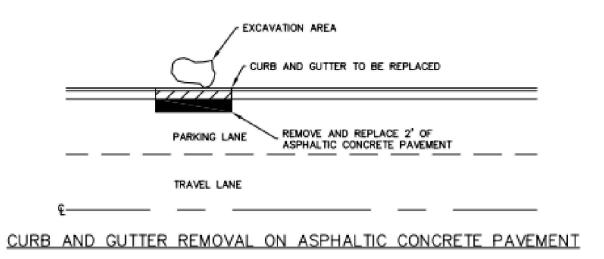

1. IF EXCAVATION OCCURS BEHIND THE CURB AND GUTTER AND INVOLES

LINE OF PAVING


CURB AND GUTTER REMOVAL AND REPLACEMENT. A TWO (2) FEET WIDE STRIP OF ASPHALT CONCRETE PAVEMENT SHALL BE REMOVED AND REPLACED.

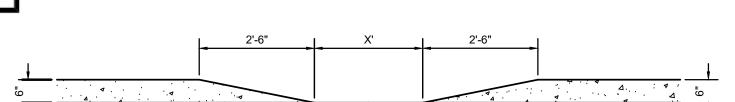

NOT TO SCALE

**CURB CUT DETAIL** 

LINE OF PAVING

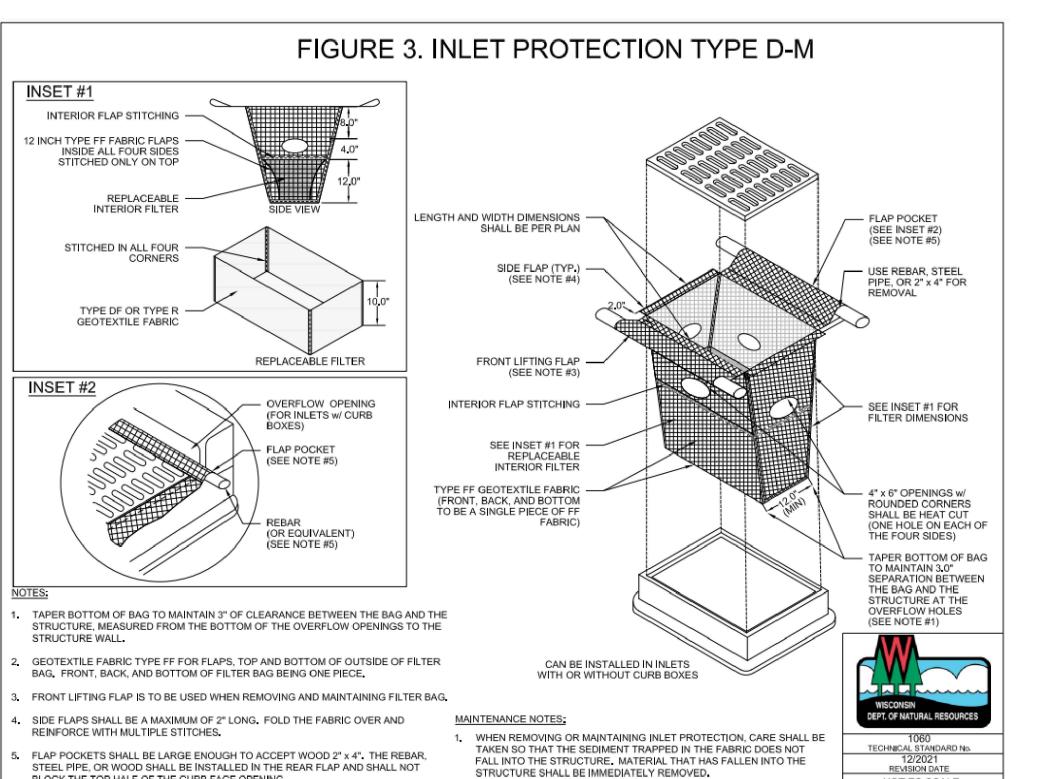



Milwaukee Area (414) 259-1181 Hearing Impaired TDD (800) 542-2289 www.DiggersHotline.com

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4

ONST.; SUITE

STEVEN KOLAR

rawing Scale: 10/06/2023

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10/06/2023

SITE LANDSCAPE PERCENTAGE

LANDSCAPE DESIGN COMPLIANCE: THIS LANDSCAPE PLAN IS ACCURATE AND IN COMPLAINACE WITH THE CITY OF DE PERE LANDSCAPE REQUIREMENTS SET FOR IN SECTION 14.100 LANDSCAPE AND SCREENING: 14-102 14-102 Street Right-of-Way Trees

#### (3) Requirements

#### (a)Number

At least one large tree is required per 35 feet of street frontage. If large trees are not appropriate due to the presence of overhead lines, other obstructions or site visibility considerations, as determined by the city forester, at least one small tree is required per 30 feet of street frontage, or when compliance with street tree planting location requirements would result in improper aesthetics or a poor growing environment for the tree or damage to public or private improvements.

3. Required street trees must be located within pervious landscape areas or within tree wells.

#### STREET FRONTAGE = 245 LINEAL FEET THEREFORE 7 STREET TREES REQUIRED

#### 7 STREET TREES PROVIDED

(4) Spacing: Street trees are not required to be evenly spaced, but the distance between street trees may not exceed 75 feet.

#### Parking Lot Screening

(1) Purpose The parking lot screening regulations of this section are intended to help mitigate the visual and operational impacts of parking lots when such areas are adjacent to streets or residential zoning districts.

#### (3) Requirements (a)Screening from Street Frontage

1. When a parking lot is located adjacent to a street right-of-way, parking lot screening must be provided in accordance with the regulations of this section to visually screen the parking lot from the right-of-way.

2. Parking lot screening is required only when the parking lot is located within

100 feet of the right-of-way and there are no intervening buildings between the parking lot and the right-of-way.

vehicle using the space. Ground cover plants or mulch must be provided in the allowed vehicle overhang area.

## 3. Parking lot screening areas must be at least 7 feet in width;

#### 4. Parking lot screening must be provided in the form of one of the following:

a. A vegetative screen consisting of shrubs planted to form a continuous visual barrier (hedge) at least 3 feet in height accompanied by wrought-iron fencing between 3 and 6 feet in height installed on the street side of the shrubs; or

#### b. A screening wall with a minimum height of 3 feet and a maximum height of 3.5 feet. Walls used

to satisfy parking lot screening requirements must be constructed of brick, stone, cast stone, formed concrete or similar durable, low- maintenance materials.

#### a) Vehicle Overhangs

A portion of a motor vehicle parking space may be landscaped instead of paved to meet parking lot screening requirements. The landscaped area may be up to 2.5 feet of the front of the space, as measured from a line parallel to the direction of the bumper of the

#### 14-104 14-104Parking Lot Interior Landscaping

#### (4) Requirements

(a)Trees; Required parking lot interior landscape areas must include at least one large tree per 20 parking spaces. Small trees may be substituted for large trees if the zoning administrator determines that the presence of overhead lines or other obstructions or site visibility considerations make the installation of large trees unsafe or impractical.

(b) Location and Design 1. Required trees must be reasonably distributed throughout the parking

lot and provided in landscape islands or medians that comply with all the following requirements:

They must be bordered by a paved surface on at least 2 sides;

c. They must be at least 7 feet wide, as measured from the back of the curb; and they must be protected by curbs or other barriers,

which may include breaks or inlets to allow stormwater runoff to enter the landscape area. 2. Parking rows that end abutting a paved driving surface must have a landscape terminal island (end cap) with at least one tree at

each end of the parking row. All other parking lot landscape islands must be located to comply with all applicable regulations of this

3. The zoning administrator is expressly authorized to approve landscape plans that do not provide terminal islands

at the end of each parking row or that otherwise provide for reduced dispersal of interior parking lot landscape areas when proposed landscape planting areas are combined to form functional bioretention areas or to preserve existing trees and vegetation

#### 14-105 14-105 Foundation Landscaping

(a) Foundation planting areas must be provided abutting each principal building along at least 60% of length of any street-facing building

(b) Foundation planting areas must have a minimum width of 5 feet, as measured from the exterior wall of the building.

### (c) Required foundation planting areas must contain any combination of ornamental

trees, evergreen trees, shrubs, flowering plants, ground cover plants, and other native or ornamental grasses and plants.

(d) All areas abutting a building that are not paved and not otherwise landscaped as required by this section must be covered by mulch, grass

## or ground cover plants.

### (e) Foundation planting areas must:

1. Screen mechanical equipment, air conditioning units and other equipment from view of street;

Provide visual relief along large expanses of building walls and accent building entrances and architectural features; and

Enhance walkways, entrances, outdoor seating areas, and other pedestrian areas.

### 14-106 14-106 Landscape and Screening Material

(2) Trees (a) Size of New Trees. New or transplanted trees provided to satisfy the requirements of this zoning ordinance must comply with the following

1. Large trees must be deciduous, with a minimum caliper size of 2 inches and a minimum height of 10 feet at the time of installation.

2. Medium trees must have a minimum caliper size of 2 inches and a minimum height of 8 feet at the time of installation.

3. Small trees must have a minimum caliper size of 1.5 inches and a minimum height of 6 feet at the time of installation.

### 4. Evergreen trees must have a minimum height of 6 feet at the time of installation.

### (a)New Shrubs

1. Shrubs must have a minimum container size of 5 gallons.

Shrubs may also be balled and burlapped.

CONTRACTOR NOTE: THE LANDSCAPE CONTRACTOR/GENERAL CONTRACTOR ARE RESPONSIBLE TO INSTALL THE LANDSCAPE AS PER THE APPROVED PLAN. IF ANY CHANGES OR DEVIATIONS ARE MADE FROM THE THIS APPROVED PLAN, THE LANDSCAPE CONTRACTOR / GENERAL CONTRACTOR ARE RESPONSIBLE FOR UPDATING THE PLANS ACCORDINGLY AND SUBMITTING THOSE REVISED PLANS FOR APPROVAL AND "SIGN OFF" WITH THE CITY OF DE PERE. THE LANDSCAPE CONTRACTOR / GENERAL CONTRACTOR ARE ALSO RESPONSIBLE FOR VERIFYING THAT ANY PLANT MATERIAL SUBSTITUTIONS OR MODIFICATIONS THAT ARE MADE TO THE APPROVED LANDSCAPE DESIGN DOCUMENTS WILL NOT CHANGE OR ALTER ANY OF THE REQUIRED SUPPORTING LANDSCAPE REQUIREMENT CALCULATIONS. UPON COMPLETION OF THE CONSTRUCTION PROJECT AND FILE THAT AFFIDAVIT WITH THE CITY OF DE PERE

#### LANDSCAPE PLAN GENERAL NOTES

#### PLANT MATERIAL SHOWN ON LANDSCAPE PLAN IS DEPICTED AT MATURE GROWTH,

1. AT LEAST SEVENTY-TWO HOURS PRIOR TO ANY EXCAVATION, CONTRACTOR SHALL VERIFY UTILITY LOCATIONS AS GIVEN BY THE ELECTRIC, GAS, TELEPHONE, WATER, SEWER, AND CABLE TELEVISION COMPANIES, UTILITIES OR ENTITIES. REVIEW WITH OWNER'S REPRESENTATIVE SITE MECHANICAL, SITE ELECTRICAL AND LIGHTING, SITE GRADING AND DRAINAGE, SITE IRRIGATION AND ALL OTHER DRAWINGS PERTAINING TO UNDERGROUND UTILITY LOCATIONS. RECORD SET OF INFORMATION THE SAME AS IN POSSESSION OF OWNER'S REPRESENTATIVE. ALSO REVIEW OWNER'S "MARK SETS" OF ALL OF THESE DRAWINGS IN POSSESSION OF THE CONTRACTOR OR OWNER. MARK ALL SUCH UTILITIES ON THE SITE PRIOR TO COMMENCING. COORDINATE WITH OWNER BEFORE AND DURING CONSTRUCTION. REPAIR ANY DAMAGE TO ANY SYSTEM THAT IS CAUSED BY LANDSCAPE CONTRACTOR AT NO COST TO OWNER.

2. ALL PLANTINGS SPECIFIED FOR THE XXXXXXXXXX PROJECT PLANTING TABLES SHALL COMPLY WITH STANDARDS AS DESCRIBED IN AMERICAN STANDARD OF NURSERY STOCK ANSI Z60.1 2014 AND ANSI STANDARDS FOR PLANTING 2012.

3. ALL DEVIATIONS FROM THE APPROVED XXXXXXXXXX PROJECT PLANS SHALL BE NOTED ON THE RECORD DRAWINGS BY THE CONTRACTOR AND MAY BE EXECUTED ONLY WITH PRIOR APPROVAL FROM THE LANDSCAPE ARCHITECT AND OWNER'S REPRESENTATIVE, VERBAL AGREEMENTS OR REVISIONS WITHOUT A CHANGE ORDER WILL NOT BE RECOGNIZED BY LANDSCAPE ARCHITECT AND OWNER.

4. ALL PLANTS MUST BE BID AND SELECTED PER THE SPECIES SPECIFIED ON THE PLANS. ANY SPECIES SUBSTITUTIONS MUST BE APPROVED IN WRITING BY LANDSCAPE ARCHITECT. THE SIZES OF PLANT MATERIAL LISTED HEREIN IS A MINIMUM ACCEPTABLE SIZE. ADDITIONALLY, IF EXCESSIVE PRUNING REDUCES THE CROWN THE PLANT SHALL BE REPLACED.

5. PROTECT PUBLIC FROM CONSTRUCTION WITH BARRIERS AND BARRICADES.

ALL AREAS THAT WERE DISTURBED DURING CONSTRUCTION AND AREAS NOT COVERED WITH PAVEMENT, BUILDING, PLANTING BEDS, OR TREE PITS ARE TO BE TOPSOILED 3" DEEP (MIN.) AND SHALL BE SODDED/SEEDED WITH SPECIFIED LAWN GRASS. LANDSCAPE CONTRACTOR SHALL INCLUDE COST PER SQUARE YARD FOR ADDITIONAL SEED OPERATIONS AS MAY BE POSSIBLY REQUIRED TO REESTABLISH ADJACENT TURF GRASS AREAS WHICH MAY BECOME DAMAGED DURING THE CONSTRUCTION PROCESS OR TO REPAIR DAMAGE DONE BY OTHERS.

7. CONTRACTOR IS RESPONSIBLE FOR FURNISHING ALL MATERIALS, TOOLS, EQUIPMENT, LABOR, AND PLANTS NECESSARY FOR PROPER PLANTING AND INSTALLATION OF ALL LANDSCAPE MATERIAL.

8. QUANTITIES ON PLANT MATERIALS LIST ARE FOR CONVENIENCE OF BIDDING ONLY. CONTRACTOR IS RESPONSIBLE FOR ALL PLANTS SHOWN ON LANDSCAPE PLANS AND COVERAGE OF ALL AREAS DELINEATED. THE PLANS ARE TO SUPERSEDE THE PLANT LIST IN ALL CASES.

9. CONTRACTOR IS RESPONSIBLE FOR ALL ESTIMATING AND BIDDING, ALL AREAS, QUANTITIES MATERIALS SHOULD BE FIELD VERIFIED WITH SITE

10. WHERE DISCREPANCIES OCCUR BETWEEN THE LANDSCAPE PLANS AND/OR ARCHITECTURAL AND/OR THE CIVIL DRAWINGS (AND ANY OTHER SITE DRAWINGS) THE DISCREPANCIES MUST BE BROUGHT TO THE LANDSCAPE ARCHITECTS ATTENTION FOR COORDINATION AND RESOLUTION.

11. ALL DISEASED, NOXIOUS OR INAPPROPRIATE MATERIALS SHALL BE REMOVED FROM THE PROPOSED SITE PRIOR TO THE START OF

12. GENERAL CONTRACTOR SHALL LEAVE THE SITE FREE OF CONSTRUCTION DEBRIS.

CONSTRUCTION AND DURING THE MAINTENANCE PERIOD.

13. ALL LAWN AND PLANTING AREAS SHALL SLOPE TO DRAIN A MINIMUM OF 2% UNLESS NOTED OTHERWISE AND REVIEWED WITH OWNER'S REPRESENTATIVE FOR FINAL APPROVAL.

14. FINISH GRADES FOR SHRUB AND GROUND COVER AREAS SHALL BE HELD 1" BELOW TOP OF ADJACENT PAVEMENTS AND CURBS, UNLESS NOTED OTHERWISE ON THE PLANS. REFER TO LSP1.3 FOR FURTHER INFORMATION.

15. ALL PERENNIAL, ANNUAL AND GROUND COVER AREAS TO RECEIVE A BLEND OF ORGANIC SOIL AMENDMENTS PRIOR TO PLANTING. TILL THE FOLLOWING MATERIALS INTO EXISTING TOPSOIL TO A DEPTH OF APPROXIMATELY 8". A DEPTH OF 12" IN TREE PITS. PROPORTIONS AND QUANTITIES MAY REQUIRE ADJUSTMENT DEPENDING ON THE CONDITION OF EXISTING SOIL. REFER TO LSP1.3 FOR FURTHER INFORMATION. PER EVERY 100 SQUARE FEET ADD: ONE - 2 CUBIC FOOT BALE OF PEAT MOSS, 2 POUNDS OF 5 -10 -5 GARDEN FERTILIZER, 1/4 CUBIC

16. ALL SHRUBS TO BE POCKET PLANTED WITH A 50/50 MIX OF COMPOSTED, ORGANIC MATERIAL AND EXISTING SOIL. INSTALL TOPSOIL INTO ALL BEDS AS NEEDED TO ACHIEVE PROPER GRADE. REMOVE ALL EXCESSIVE GRAVEL, CLAY AND STONES. REFER TO LSP1.3 FOR FURTHER

17. PLANT ALL TREES SLIGHTLY HIGHER THAN FINISHED GRADE AT ROOT FLARE. BACK FILL HOLE WITH 2/3 EXISTING TOPSOIL AND ORGANIC SOIL AMENDMENTS SPECIFIED IN NOTE 15. AVOID ANY AIR POCKETS. DISCARD ANY GRAVEL CLAY OR STONES. REFER TO LSP1.3 FOR FURTHER

18. ALL TREES TO BE INSTALLED, STAKED AND GUYED ACCORDING TO DETAILS. REFER TO ANSI STANDARDS FOR PLANTING 2012 AND DETAILS ON LSP1.3 FOR FURTHER INFORMATION.

19. PROVIDE A 4'-0" - 5'-0" DIAMETER MULCH RING AT THE ROOT BALL FLARE OF ALL LAWN TREES.

YARD OF COMPOSTED MANURE OR OTHER COMPOSTED, ORGANIC MATERIAL.

20. ALL PLANTINGS TO BE WATERED AT THE TIME OF PLANTING, THROUGHOUT CONSTRUCTION AND UPON COMPLETION OF PROJECT AS REQUIRED.

WHERE SPECIFIED, ALL PLANT BEDS, PITS AND TREE RINGS ARE TO RECEIVE A MINIMUM OF 2" - 3" DRESSING OF SHREDDED HARDWOODM OAK BARK MULCH SHAVINGS FREE OF GROWTH, WEEDS, FOREIGN MATTER DETRIMENTAL TO PLANT LIFE OR GERMINATION INHIBITING INGREDIENTS. LANDSCAPE CONTRACTOR TO PROVIDE A SAMPLE TO OWNER FOR APPROVAL. CONTRACTOR TO TAKE CARE WITH INSTALLATION NOT TO DAMAGE OR COVER PLANTS. REFER TO LSP1.3 FOR FURTHER INFORMATION.

22. LAWN INSTALLATION: CONTRACTOR TO FURNISH AND PREPARE TOPSOIL (3" MIN) AND SEED BED (REMOVE ALL STONES 1" OR LARGER), APPLY STARTER FERTILIZER AND SEED UNIFORMLY. PROVIDE A MULCH COVERING SUITABLE TO GERMINATE AND ESTABLISH TURF. EROSION CONTROL MESH SHOULD BE USED IN SWALES AND STEEP GRADES WHERE APPLICABLE. METHODS OF INSTALLATION MAY VARY AT THE DISCRETION OF CONTRACTOR. IT IS HIS/HER RESPONSIBILITY TO ESTABLISH AND GUARANTEE A SMOOTH, UNIFORM, QUALITY TURF. IF STRAW MULCH IS USED AS A COVERING, A TACKIFIER MAY BE NECESSARY TO AVOID WIND DAMAGE.

### 23. DELUXE 50 GRASS SEED MIX REINDER'S (800) 785-3301

20% KENTUCKY BLUE GRASS

15% NEWPORT KENTUCKY BLUE GRASS 15% SR 2100 Kentucky Bluegrass

25% Creeping Red Fescue

15% Replicator Perennial Ryegrass 10% Fiesta 4 Perennial Ryegrass

APPLY AT A RATE OF 200 POUNDS PER ACRE. REFER TO SUPPLIERS SPECIFICATIONS & INSTALLATION CUT SHEETS FOR FURTHER FORMATION

24. DURING THE INITIAL "30 DAY MAINTENANCE PERIOD" THE LANDSCAPE CONTRACTOR IS REQUIRED TO PROVIDE AND ON-GOING PLEASANT VISUAL ENVIRONMENT WHEREAS ANY PLANT WHICH IS NOT RESPONDING TO TRANSPLANTING OR THRIVING SHALL IMMEDIATELY BE REPLACED. NEW LAWNS SHALL BE WATERED AND REPAIRED AND WEEDS MUST CONSTANTLY BE REMOVED, NO EXCEPTIONS WILL BE GRANTED.

MAINTENANCE IS THE RESPONSIBILITY OF THE PROPERTY OWNER TO MAINTAIN REQUIRED LANDSCAPING IN ACCORDANCE WITH THE MUNICIPALITY'S PROPERTY MAINTENANCE CODE AND AN APPROVED MAINTENANCE PLAN. THE MAINTENANCE MUST INCLUDE, AT A

MINIMUM, METHODS FOR PROVIDING THE FOLLOWING:

NECESSARY IRRIGATION (if REQUIRED)

 INTEGRATED PEST MANAGEMENT, PROPER FERTILIZATION

TREE CARE AND PRUNING, SHRUB TIP CLIPPING AND SHAPING AS REQUIRED

THIS SURVEY ARE APPROXIMATE. THERE MAY BE

OTHER UNDERGROUND UTILITY INSTALLATIONS

WITHIN THE PROJECT AREA THAT ARE NOT SHOWN.

REPLACEMENT OF LOST VEGETATION, AND ALL DISEASED, DAMAGED, OR DEAD MATERIAL WILL BE REPLACED BY THE END OF THE

FOLLOWING PLANTING SEASON IN PERPETUITY. WEED MANAGEMENT AND BED CARE.

25. ALL NEWLY PLANTED TREES AND SHRUBS ARE TO RECIEVE AN APPLICATION OF AN ANTI-TRANSPIRANT SPRAY THAT WILL EFFECTIVELY REDUCE THE WATER LOSS OF TRANSPIRATION OF PLANT MATERIAL AND REDUCE THE STRESS OF TRANSPLANTATION. IT IS RECOMENDED AS PART OF THE ONGOING MAINTENANCE THAT ANY BROADLEAF EVERGREEN AND CONIFEROUS TREE AND SHRUBS (EXCLUDING ARBORVITAE) RECIEVE AN APPLIATION OF AN ANTI-DESICANT SPRAY TO REDUCE THE LOSS OF MOISTURE DUE TO WINTER DESICCATION.

26. MAINTENANCE. THE OWNER SHALL TEND AND MAINTAIN ALL PLANT MATERIALS IN A HEALTHY GROWING CONDITION AS PER THE APPROVED PLAN. PLANTINGS SHALL BE REPLACED WHEN NECESSARY AND KEPT FREE FROM REFUSE & DEBRIS. ALL PLANTING MATERIAL WHICH IS DYING OR DAMAGED BEYOND RECOVERY SHALL BE REPLACED WITHIN SIX (6) MONTHS OR BY THE NEXT PLANTING SEASON, WHICHEVER COMES FIRST.

27. LANDSCAPE / SITE DEMOLITION CONTRACTOR TO VERIFY LOCATIONS OF EXISTING TREES AND SHRUBS TO BE SALVAGED AND CLEARLY TAG

THEM WITH MARKING TAPE AND CONSTRUCTION FENCE. TO OBTAIN LOCATION OF PARTICIPANT'S UNDERGROUND FACILITIES BEFORE YOU DIG IN WISCONSIN WISCONSIN STATUTE 182.0175 (1974) REQUIRES A MINIMUM OF 3 DAYS NOTICE BEFORE YOU EXCAVATE (NOT INCLUDING SATURDAY, SUNDAY OR LEGAL HOLIDAYS) UNDERGROUND SEWER AND UTILITY INFORMATION TO OBTAIN LOCATION OF AS SHOWN IS OBTAINED FROM THE RECORDS OF MUNICIPALITY AND LOCAL UTILITY COMPANIES. UNDERGROUND FACILITIES THE ACCURACY OF WHICH CAN NOT BE BEFORE YOU DIG IN WISCONIN OF EXISTING UTILITY INSTALLATIONS AS SHOWN ON ALERT NETWORK

www.Diggershotline.com

(800)-242-8511

Know what's below.

Call 811 before you dig

#### PHOTOMETRIC PLAN GENERAL NOTES

1. BASED ON THE INFORMATION PROVIDED, ALL DIMENSIONS AND LUMINAIRE LOCATIONS SHOWN REPRESENT RECOMMENDED POLE PLACEMENTS AND LUMINAIRE ORIENTATION. THE ENGINEER AND/OR ARCHITECT MUST DETERMINE APPLICABILITY OF THE LAYOUT TO RELEVANT FIELD CONDITIONS.

2. THE DEPICTED ILLUMINATION RESULTS ARE BASED UPON ILLUMINATION MEASUREMENTS AS CALCULATED BY AN INDEPENDENT LABORATORY. LUMINAIRE CHARACTERISTICAL DATA WAS MEASURED UNDER CONTROLLED CONDITIONS IN ACCORDANCE WITH APPROVED ILLUMINATION ENGINEERING SOCIETY METHODS. ACTUAL ON-SITE PERFORMANCE OF ANY MANUFACTURER'S LUMINAIRES MAY VARY FROM LABORATORY TEST RESULTS DUE TO VARIATIONS IN: ELECTRICAL VOLTAGE, TOLERANCE IN LAMPS, AND OTHER VARIABLE FIELD CONDITIONS.

3. IF EXISTING LUMINAIRES ARE INCLUDED IN THIS REPORT, THEIR ILLUMINATION CHARACTERISTICS ARE BASED UPON A COMBINATION OF CUSTOMER'S PROVIDED SPECIFICATIONS & OUR BEST ESTIMATION.

4. ALL EXISTING AND NEW CONCRETE LIGHT POLE BASES ARE TO HAVE ALL FORM MARKS REMOVED, GROUND FLUSH AND THE SURFACE IS TO BE PROPERLY PREPARED TO RECEIVE A HAND TROWELED, MASONRY SKIM COAT OF APPROPRIATE THICKNESS TO ACHIEVE A DURABLE SURFACE AND LONG LASTING AESTHETIC.

#### **EXISTING CONDITIONS GENERAL NOTES**

INFORMATION PERTAINING TO EXISTING CONDITIONS GIVEN ON THESE ARCHITECTURAL DRAWINGS REPRESENTS TO THE BEST OF OUR KNOWLEDGE THE ACTUAL EXISTING FIELD CONDITIONS. INSITE LANDSCAPE DESIGN, INC. MAKES NO WARRANTY AS TO THEIR ACCURACY. CONTRACTOR TO FIELD VERIFY EXISTING CONDITIONS IMPERATIVE TO THEIR NEW WORK. REPORT ANY DISCREPANCIES BETWEEN THE DRAWINGS AND FIELD CONDITIONS TO THE LANDSCAPE ARCHITECT FOR REVIEW. ANY WORK PERFORMED PRIOR TO RESOLUTION OF DISCREPANCIES BY THE LANDSCAPE ARCHITECT IS SUBJECT TO REMOVAL AND REPLACEMENT AT NO ADDITIONAL COST TO THE CONTRACT.

2. VERIFY LOCATION OF ALL EXISTING UNDERGROUND UTILITIES I.E. WATER, SEWER, ELECTRICAL, TELECOMUNICATION AND ACCESS PANELS FOR ALL UTLITIES AND ALL ASSOCIATED EQUIPMENT FOR ACCESSIBILITY OF

3. VERIFY ALL EXISTING CONDITIONS, DIMENSIONS, AND ALIGNMENT OF WALLS, BRING ANY DISCREPANCIES TO THE LANDSCAPE ARCHITECTS ATTENTION PRIOR TO FABRICATION / CONSTRUCTION BEGINS.

LIGHTING DESIGN COMPLIANCE: THIS SITE LIGHTING/PHOTOMETRIC LIGHT LEVEL CALCULATIONS PLAN IS ACCURATE AND IN COMPLIANCE WITH THE CITY OF DE PERE LIGHTING REQUIREMENTS SET FOR IN SECTION 14-95 REQUIREMENTS AND IS DARK SKY COMPLIANT AS IDENTIFIED IN ZONING ORDINANCE 14-95 AND LISTED BELOW.

14-095 Outdoor Lighting TABLE 9-5 -- MAXIMUM LIGHT TRESPASS All Other Zoning- BP-1 - 0.50


(b) Dark Sky-Compliant Lighting The city requires the use of dark sky- compliant lighting fixtures and installation practices.


#### (c)Light Color Standard


The correlated color temperature of any outdoor light source may not exceed 3,000 Kelvin unless introduced as part of a facade or landscape lighting scheme used inclusively for the decorative illumination through color of certain building facade or landscape features. Any decorative illumination must be turned off between 10:00 p.m. and 6:00 a.m., local time.


## (d) Mounted Fixture Height

Parking lot lighting must be mounted no higher than 30 feet of average grade at the base. All other on-site lights must be mounted no higher than 15 feet above grade directly below the fixture.

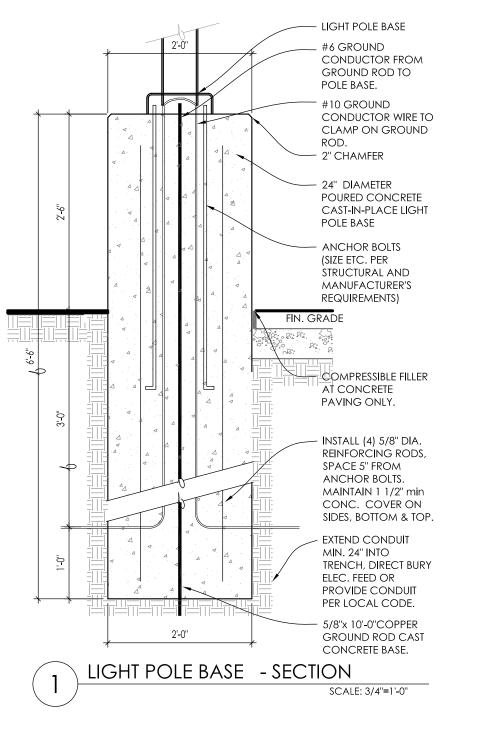

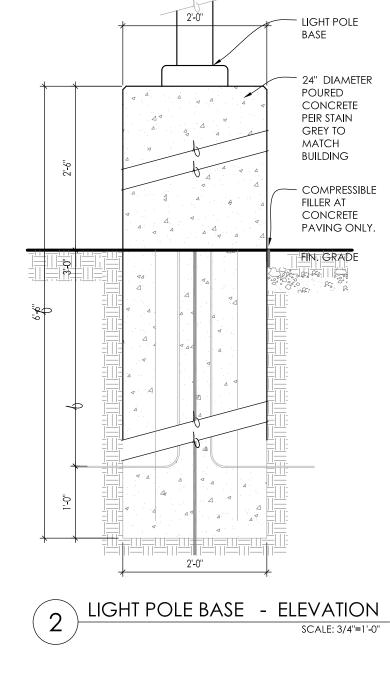

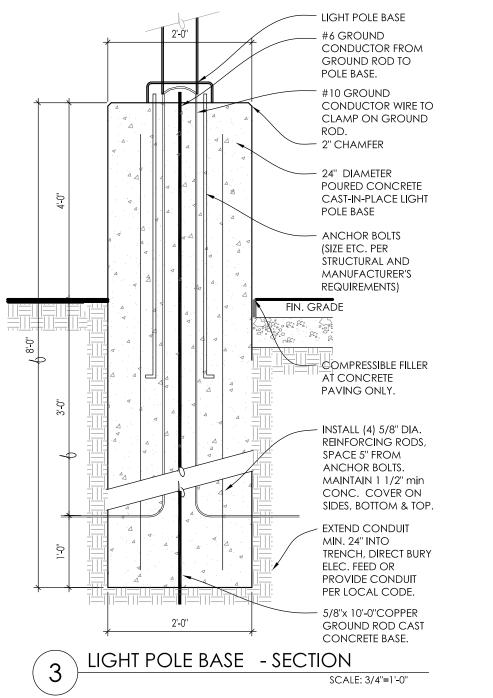

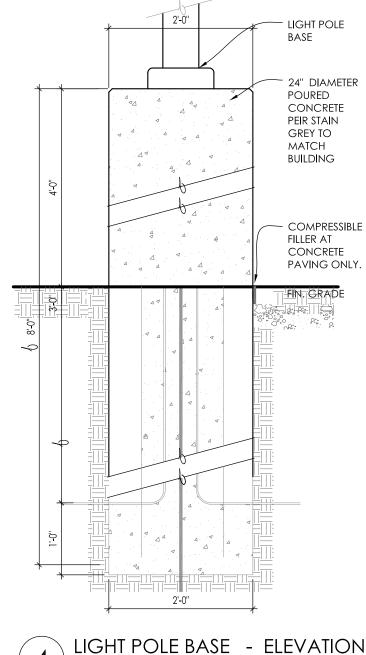

SCALE: 3/4"=1'-0" ALL EXISTING AND NEW CONCRETE LIGHT POLE BASES ARE TO HAVE ALL FORM MARKS REMOVED, GROUND FLUSH AND THE SURFACE IS TO BE PROPERLY

PREPARED TO RECEIVE A HAND TROWELED, MASONRY SKIM COAT OF APPROPRIATE THICKNESS TO ACHIEVE A DURABLE SURFACE AND LONG LASTING AESTHETIC.

LANDSCAPE Landscape Consulting

> & Master Planning Design Sevices 11525 W. North Avenue, Suite 1B Wauwatosa, WI 53226 Tel (414) 476-1204 www.insitedesigninc.com mdavis@insitedesigninc.com

## WOLTER, INC.

**DO NOT SCALE THESE** and should not be used for final bidding

1768 W. Mathew Drive De Pere, WI

Issuance and Revisions:

Date	Number	Description
08/19/23		Client Review Submittal
08/22/23		Plan Commission Submittal
09/18/23		Revisions Based on Site and Building Changes
10/06/23		Revisions Based on Staff Review

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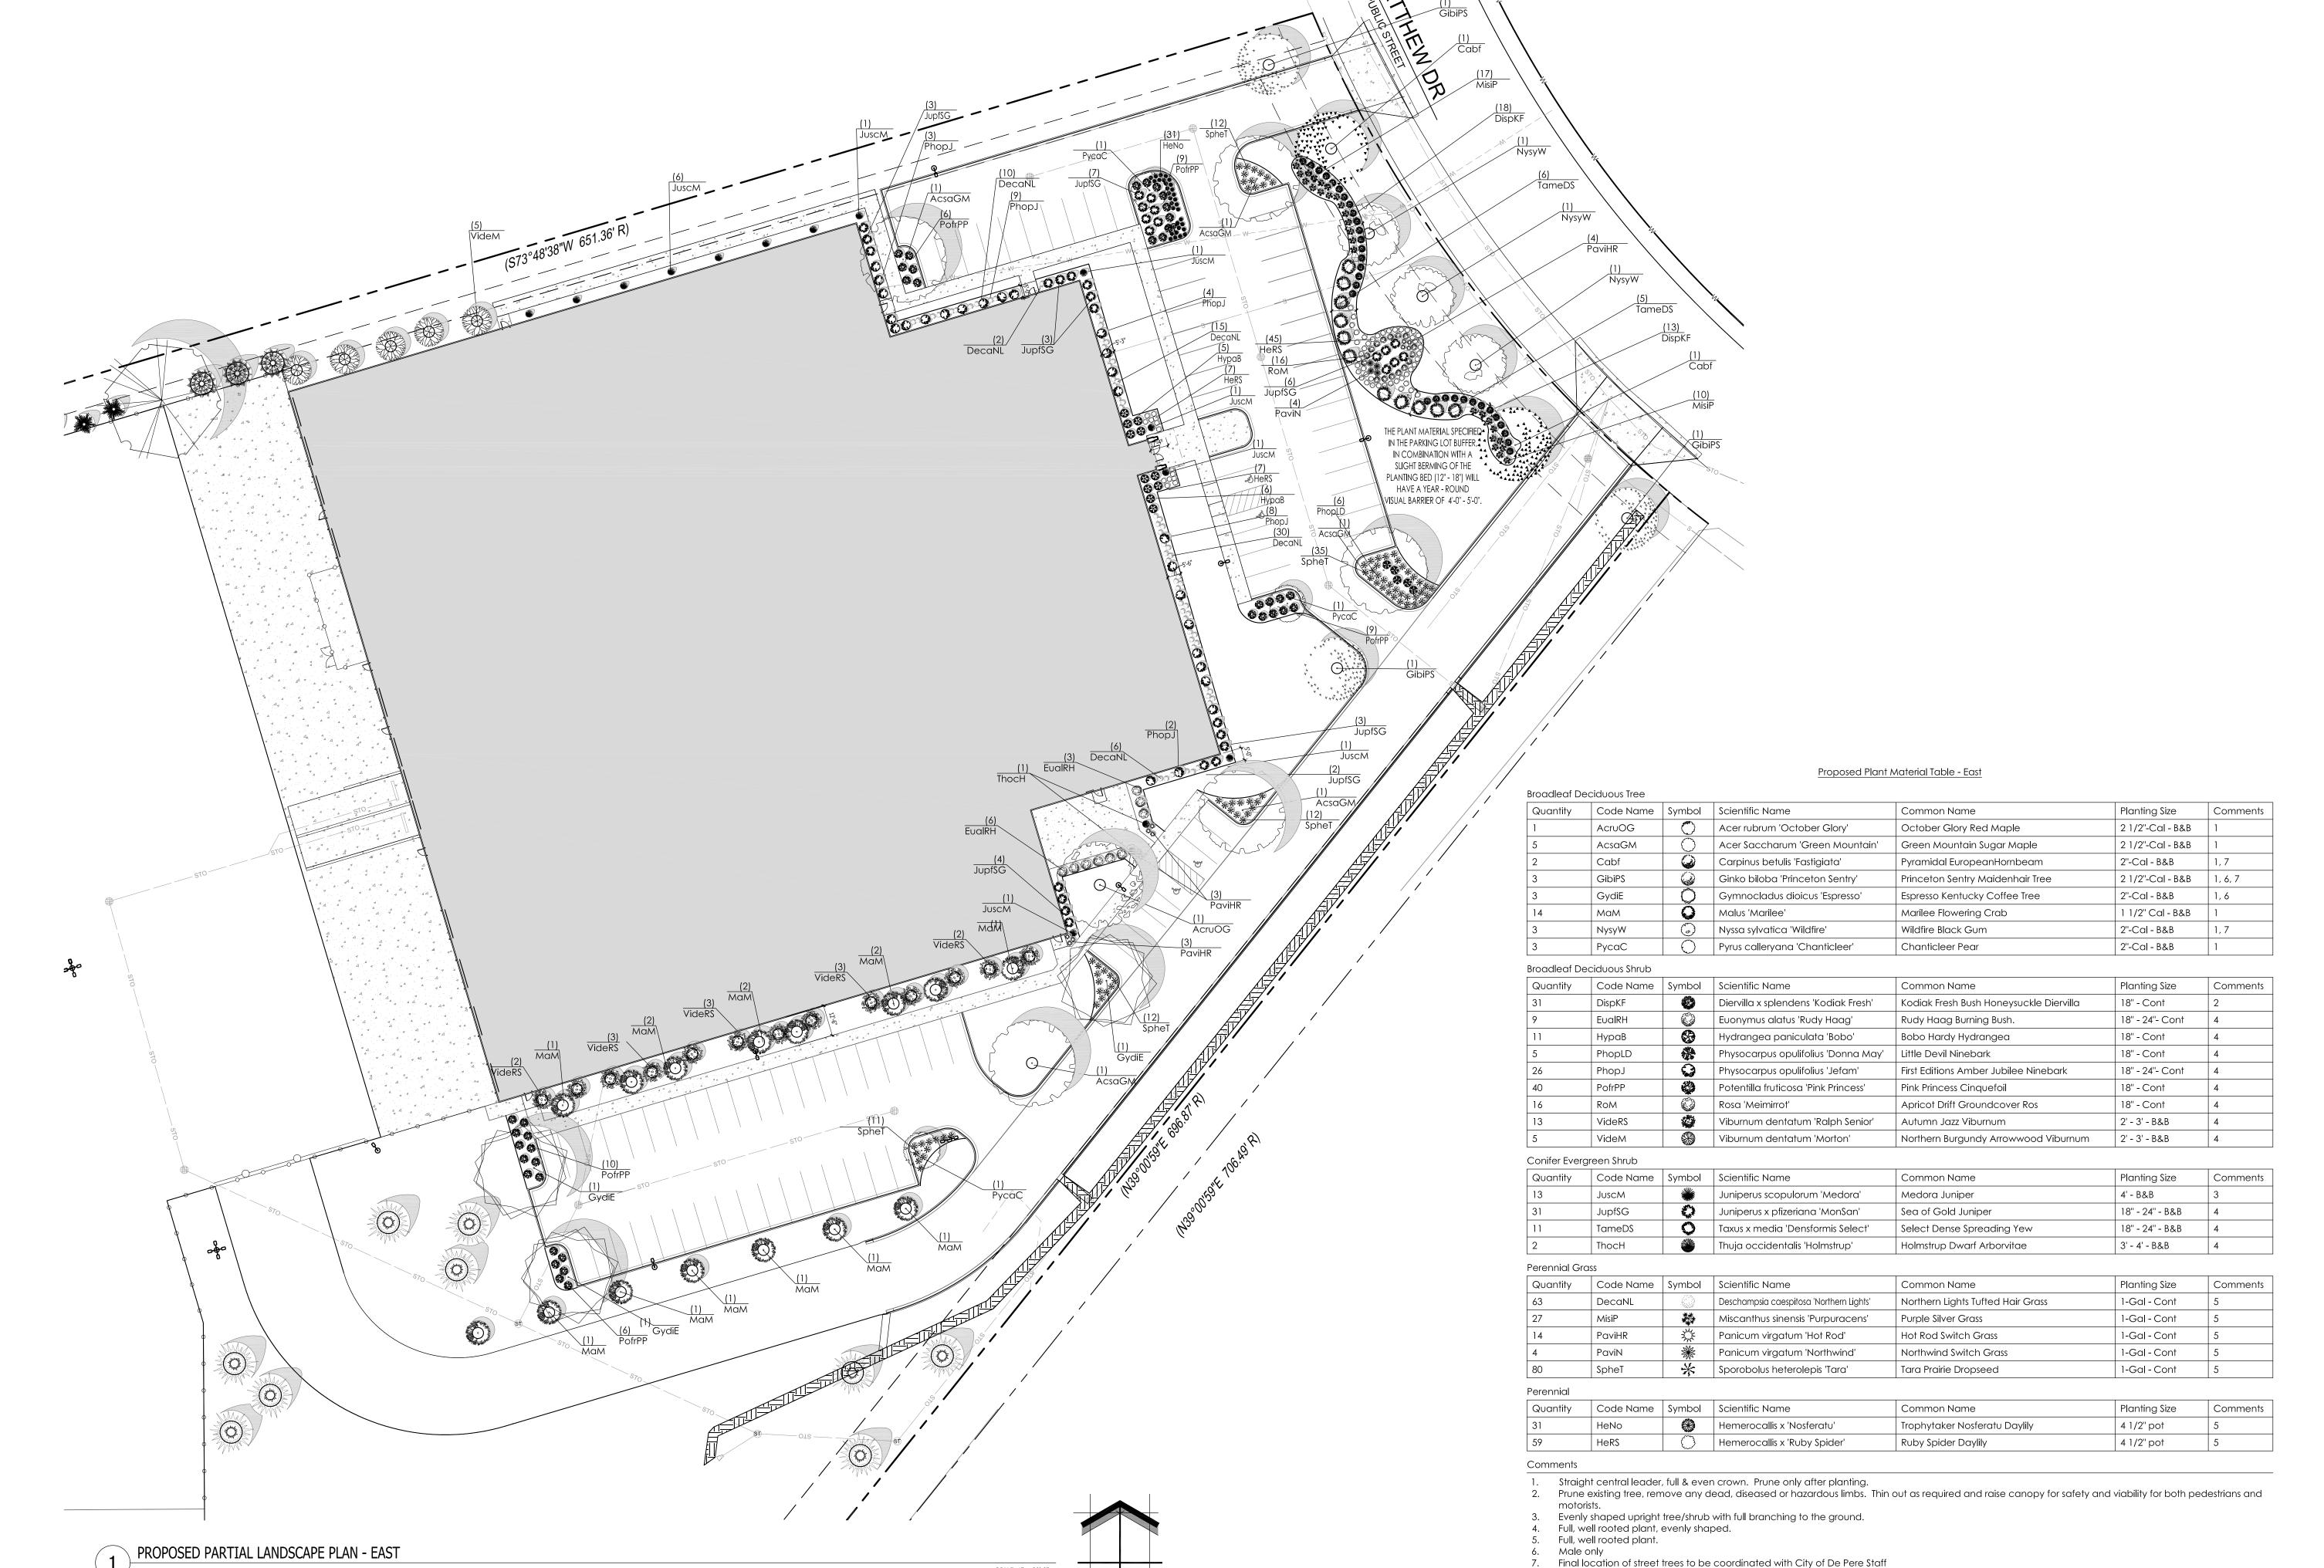
InSite Landscape Design Inc.

Sheet Title:

PROPOSED LANDSCAPE AND PROPOSED LIGHTING PLANS SITE INFORMATION & REQUIREMENTS, GENERAL NOTES, AND LIGHT POLE BASE DETAILS

Date of Drawing:	10/06/23
Scale:	NON
Drawn By:	MCI
Job Number:	L23-05

Sheet Number:



SCALE: 1" = 30'-0"

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<u>roject:</u>

# WOLTER, INC.

1768 W. Mathew Drive De Pere, WI

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Number Description

on Staff Review

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<u>Sheet Title</u>:

PROPOSED LANDSCAPE PLAN, AND PLANT MATERIAL TABLE

Date of Drawing:	10/06/23
Scale:	1" = 30'-0"
Drawn By:	MCD
Job Number:	L23-053
Sheet Number:	

LSP1.1

SCALE: 1" = 30'-0"

PROPOSED PARTIAL LANDSCAPE PLAN - WEST

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# WOLTER, INC.

1768 W. Mathew Drive De Pere, WI

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Date	Number	Description		
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on Staff Review

## Proposed Plant Material Table - West

Common Name

Serbian Spruce

Star Power Juniper

Green Giant Arborvitae

Planting Size

6' - B&B

6' - B&B

6' - B&B

Comments

2

	Broadleat Deciduous Tree							
,	Quantity	Code Name	Symbol	Scientific Name	Common Name	Planting Size	Comments	
	4	AcsaFMM	<b>₩</b>	Acer saccharrum 'Flax Mill Majesty'	Flax Mill Majesty Sugar Maple	2 1/2"-Cal - B&B	1	
	3	BeniH	<b>A</b>	Betula Nigra "Heritage"	Heritage River Birch	2 1/2"-Cal - B&B	1	
/11	1	МаМ	0	Malus 'Marilee'	Marilee Flowering Crab	1 1/2" Cal - B&B	1	
	2	UlamVF	£.3	Ulmus americana 'Valley Forge'	Valley Forge Elm	2 1/2"-Cal - B&B	1	

### ThplGG

Straight central leader, full & even crown. Prune only after planting.

Picea omorika

Juniperus 'J.N. Select Blue'

Thuja plicata 'Green Giant'

- Prune existing tree, remove any dead, diseased or hazardous limbs. Thin out as required and raise canopy for safety and viability for both pedestrians and motorists. Evenly shaped upright tree/shrub with full branching to the ground.
- Full, well rooted plant, evenly shaped.

JuJNSB

Piom

Full, well rooted plant. 6. Male only

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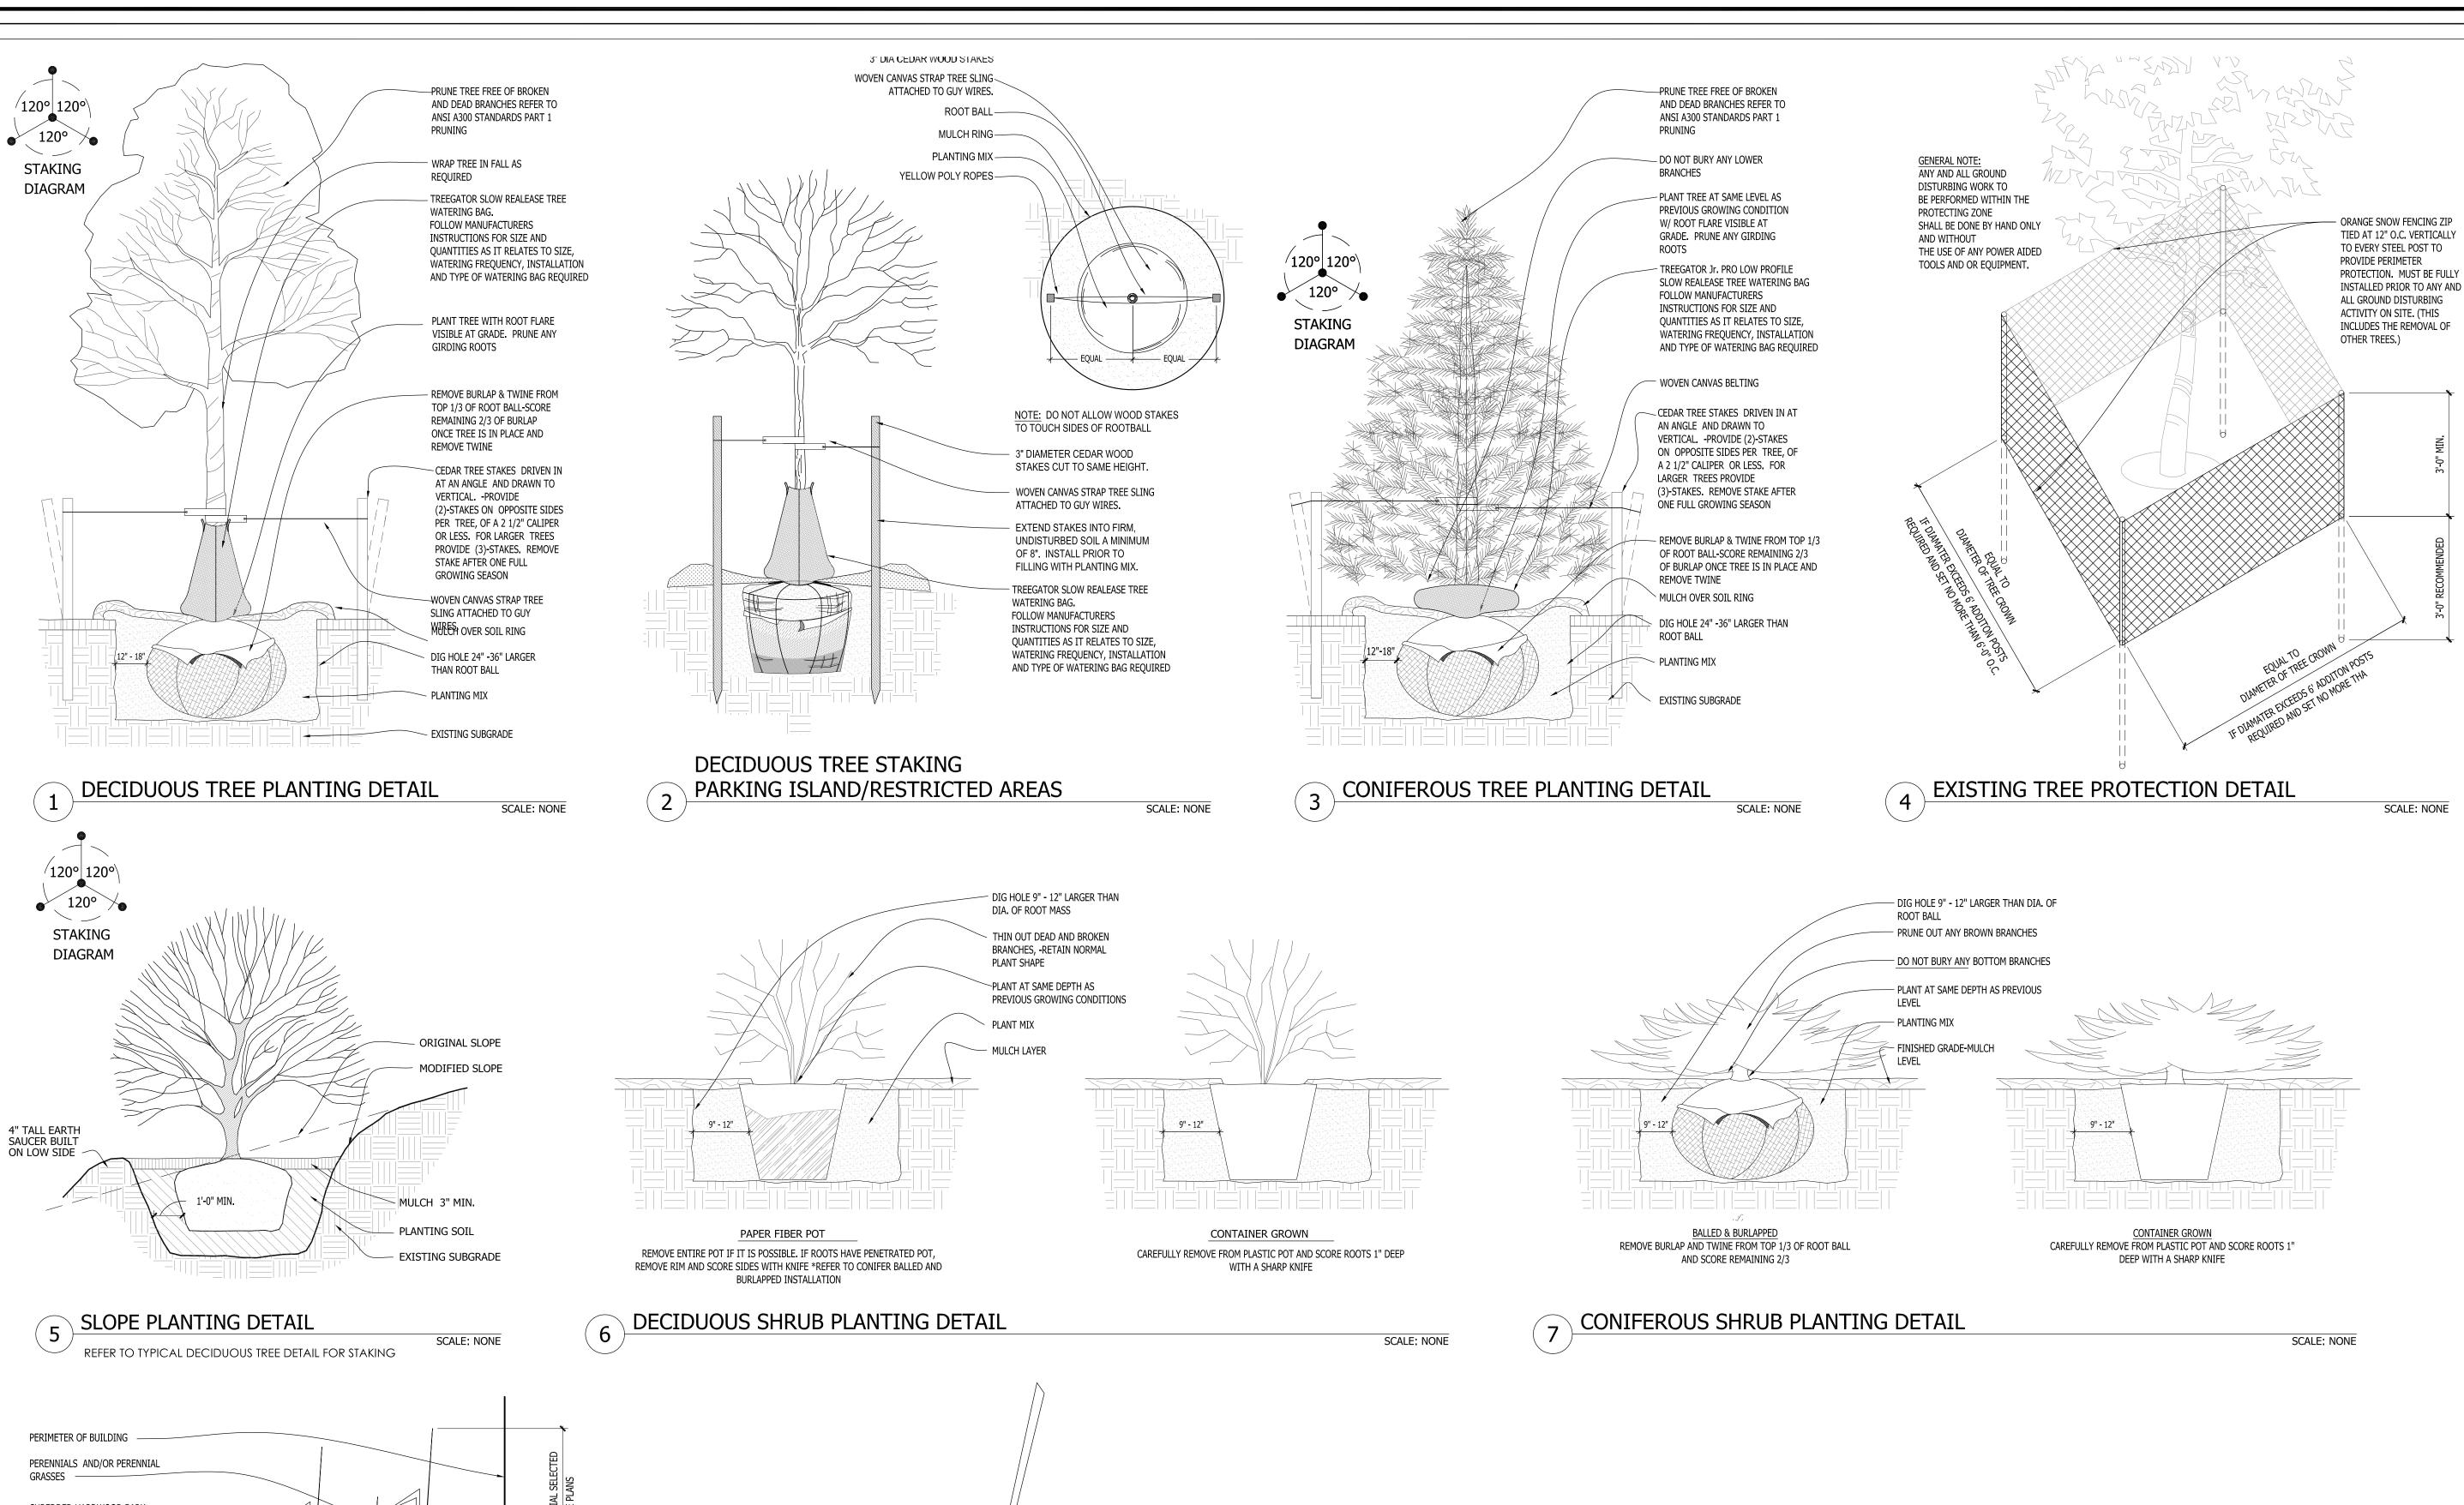
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<u>Sheet Title:</u>

PROPOSED LANDSCAPE PLAN, AND PLANT MATERIAL TABLE

Date of Drawing:	10/06/23
Scale:	1" = 30'-0"
Drawn By:	MCD
Job Number:	L23 <b>-</b> 053
Sheet Number:	



BEDLINES ARE TO BE CUT CRISP

DEFINITION BETWEEN TURF AND PLANTING BED IS REQUIRED.

AS PER PLAN. A CLEAN

TOPSOIL / PLANTING MIX

INS TE

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roject:

WOLTER, INC.

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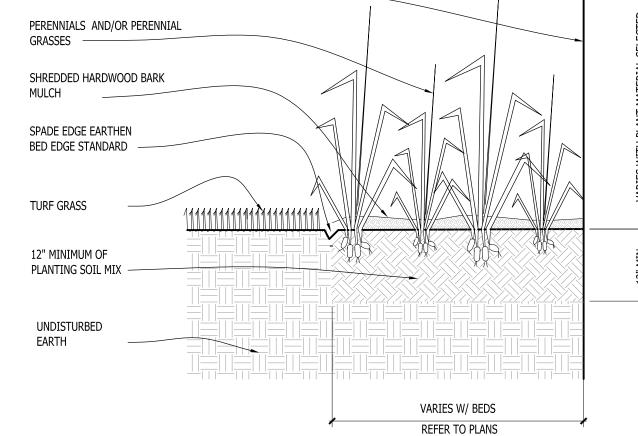
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<u>Sheet Title:</u>

PROPOSED LANDSCAPE PLAN, PLANTING DETAILS

Date of Drawing:	10/06/23
Scale:	As Noted
Drawn By:	MCD
Job Number:	L23 <b>-</b> 053
Sheet Number:	

LSP1.3





9 SPADE EDGE PLANT BED EDGE DETAIL

TOP OF MULCH SHOULD BE -

GRADUALLY.

3" (+/-) MULCH BED -

CRESTED 1-2" ABOVE TURF FOR POSITIBE DRAINGE. SLOPE

SCALE: NONE

SCALE: NONE

FIXTURE "C" (3) IS A NEW POLE LOCATION W/ NEW POLE MOUNTED FIXTURES (SINGLE HEAD AND TENONS W/ BACKLIGHT/HOUSE SIDE SHIELD). FIXTURES ARE TO BE INSTALLED ON A NEW 2'-6" TALL REINFORCED POURED CONCRETE FOUNDATION AND NEW 18'-0" DARK BRONZE POLE .

FIXTURE "F" (1) IS A NEW POLE LOCATION W/ NEW POLE MOUNTED FIXTURES (TRIPLE HEAD AND TENONS). FIXTURES ARE TO BE INSTALLED ON A NEW 2'-6" TALL REINFORCED

FIXTURE "D" (3) IS A NEW POLE LOCATION W/ NEW POLE MOUNTED FIXTURES (QUAD HEAD, TENON). FIXTURES ARE TO BE INSTALLED ON A NEW 4'-0" TALL REINFORCED

FIXTURE "E" (1) IS A NEW POLE LOCATION W/ NEW POLE MOUNTED FIXTURES (TWIN HEAD AND TENONS). FIXTURES ARE TO BE INSTALLED ON A NEW 2'-6" TALL REINFORCED

POURED CONCRETE FOUNDATION AND NEW 18'-0" DARK BRONZE POLE.

FIXTURE "G" (3) IS A NEW POLE LOCATION W/ NEW POLE MOUNTED FIXTURES (SINGLE FORWARD THROW HEAD AND TENONS). FIXTURES ARE TO BE INSTALLED ON A NEW 2'-6" TALL REINFORCED POURED CONCRETE FOUNDATION AND NEW 18'-0" DARK BRONZE POLE.

FIXTURE "H" (1) IS A NEW POLE LOCATION W/ NEW POLE MOUNTED FIXTURES (SINGLE FORWARD THROW HEAD AND TENONS). FIXTURES ARE TO BE INSTALLED ON A NEW 4'-0" TALL REINFORCED POURED CONCRETE FOUNDATION AND NEW 20'-0" DARK BRONZE POLE. PROTECT WITH 6" CONCRETE FILLED BOLLARDS AS REQUIRED.

FIXTURE "J" (2) IS A NEW POLE LOCATION W/ NEW POLE MOUNTED FIXTURES (TWIN @ 90 DEGREE INSTALL, FORWARD THROW HEAD AND TENONS ). FIXTURES ARE TO BE INSTALLED ON A NEW 4'-0" TALL REINFORCED POURED CONCRETE FOUNDATION AND NEW 20'-0" DARK BRONZE POLE . PROTECT WITH 6" CONCRETE FILLED BOLLARDS AS

ALL PROPOSED FIXTURE HEADS AND FLOOD LIGHTS ARE TO BE DARK-SKY COMPLIANT AND HAVE HARDWARE WITH IESNA FULL CUTOFF HOUSE SIDE SHIELDING WHERE

FOR CALCULATION PURPOSED MAN DOOR FIXTURES PLACED AT 10'-0" AFF AS SHOWN ON PLAN, OVERHEAD DOOR FIXTURES PLACED AT 15'-0" AFF. REFER TO

ARCHITECTURAL DRAWINGS FOR EXACT MOUNTING HEIGHTS OF ALL BUILDING MOUNTED FIXTURES. COORDINATE WITH ORDINANCE 14-095 OUTDOOR LIGHTING(D) MOUNTED FIXTURE HEIGHT: PARKING LOT LIGHTING MUST BE MOUNTED NO HIGHER THAN 30 FEET OF AVERAGE GRADE AT THE BASE. ALL OTHER ON-SITE LIGHTS MUST BE MOUNTED NO HIGHER THAN 15 FEET ABOVE GRADE DIRECTLY BELOW THE FIXTURE.

REFER TO ARCHITECTURAL DRAWINGS FOR EXACT MOUNTING HEIGHTS OF ALL BUILDING MOUNTED FIXTURES .

. CALCULATION GRID IS SHOWN IN A 5'-0" X 5'-0" SPACING AT A HEIGHT OF 0'-0"

INSTALLATION CONTRACTOR TO REFER TO ELECTRICAL PLANS FOR CONDUIT ROUTING OF LIGHT POLES AND SIGNAGE LIGHTING CONTROL AND WIRING.

13. ALL NEW CONCRETE LIGHT POLE BASES ARE TO HAVE ALL EXPOSED FORM MARKS REMOVED, GROUND FLUSH AND THE SURFACE IS TO BE PROPERLY PREPARED TO RECEIVE A HAND TROWELED, MASONRY SKIM COAT OF APPROPRIATE THICKNESS TO ACHIEVE A DURABLE SURFACE AND LONG LASTING AESTHETIC.

14. ALL NEW PROPOSED AREA LIGHT POLES SHALL BE LOCATED 3-0" FROM BACK OF CURB TO THE EDGE OR FACE OF THE REINFORCED LIGHT POLE BASE, UNLESS NOTED

OTHERWISE.

15. CONTRACTOR TO REFER TO REINFORCED LIGHT POLE BASE SECTION AND DETAIL FOR FURTHER INFORMATION.

**STATISTICS** THIS LIGHTING PLAN REPRESENTS ILLUMINATION LEVELS ARE CALCULATED VALUES INCLUDE DIRECT AND INTER-REFLECTED COMPONENT AND ILLUMINATION LEVELS CALCULATED FROM LABORATORY DATA TAKEN UNDER CONTROLLED CONDITIONS IN ACCORDANCE WITH THE ILLUMINATING ENGINEERING SOCIETY (IES) APPROVED METHODS. ACTUAL Description PERFORMANCE OF ANY MANUFACTURER'S LUMINAIRES MAY VARY DUE TO CHANGES IN ELECTRICAL VOLTAGE, TOLERANCE IN LAMPS/LED'S AND OTHER MAY VARY DUE TO CHANGES IN ELECTRICAL VOLTAGE, TOLERANCE IN LAMPS/LED'S AND OTHER VARIABLE FIELD CONDITIONS. CALCULATIONS DO NOT INCLUDE OBSTRUCTIONS SUCH AS BUILDINGS Calc Zone #1 CURBS, LANDSCAPING, OR ANY OTHER ARCHITECTURAL ELEMENTS UNLESS NOTED.

TO OBTAIN LOCATION OF PARTICIPANT'S UNDERGROUND FACILITIES BEFORE YOU DIG IN WISCONSIN (NOT INCLUDING SATURDAY, SUNDAY OR LEGAL HOLIDAYS

UNDERGROUND SEWER AND UTILITY INFORMATION TO OBTAIN LOCATION OF AS SHOWN IS OBTAINED FROM THE RECORDS OF MUNICIPALITY AND LOCAL UTILITY COMPANIES. THE ACCURACY OF WHICH CAN NOT BE GUARANTEED OR CERTIFIED TO. THE LOCATIONS CALL THE MILWAUKEE UTILITY OF EXISTING UTILITY INSTALLATIONS AS SHOWN ON THIS SURVEY ARE APPROXIMATE. THERE MAY BE OTHER UNDERGROUND UTILITY INSTALLATIONS

PARTICIPANT'S UNDERGROUND FACILITIES BEFORE YOU DIG IN WISCONIN ALERT NETWORK www.Diggershotline.com (800)-242-8511 WITHIN THE PROJECT AREA THAT ARE NOT SHOWN.



LIGHTING DESIGN COMPLIANCE: THIS SITE LIGHTING/PHOTOMETRIC LIGHT LEVEL CALCULATIONS PLAN IS ACCURATE AND IN COMPLIANCE WITH THE CITY OF DE PERE LIGHTING REQUIREMENTS SET FOR IN SECTION 14-9. REQUIREMENTS AND IS DARK SKY COMPLIANT AS IDENTIFIED IN ZONING ORDINANCE 14-95 AND LISTED BELOW.

14-095 Outdoor Lighting

TABLE 9-5 -- MAXIMUM LIGHT TRESPASS All Other Zoning- BP-1 - 0.50

(b) Dark Sky-Compliant Lighting

The city requires the use of dark sky- compliant lighting fixtures and installation practices.

(c)Light Color Standard

The correlated color temperature of any outdoor light source may not exceed 3,000 Kelvin unless introduced as part of a facade or landscape lighting scheme used inclusively for the decorative illumination through color of certain building facade or landscape features. Any decorative illumination must be turned off between 10:00 p.m. and 6:00 a.m., local time.

(d) Mounted Fixture Height

LUMINAIRE SCHEDULE

Parking lot lighting must be mounted no higher than 30 feet of average grade at the base. All other on-site lights must be mounted no higher than 15 feet above grade directly below the fixture.

symbol	Label	Qty	Catalog Number STO	Description	Lamp	File	Lumens	LLF	Watts
	А	2	BXCCAxA08-Ux7 CPY250-A-xx-F-A- UL-xx-40K	Cree CPY250 Canopy / Soffit Luminaire w- Flat Lens, 122W, 4000K	72 type XTE AWT LEDs on white square PCB. 4000K color temperature.	CPY250-A-xx- F-A-UL-xx- 40K_RESTL- 2013-0002.ies	Absolute	1.00	81.4
AT MAN	B DOOR LOO	8 CATIONS	XSPWAx3FC-U	Cree XSPW Series Wallpack Luminaire, Type III Medium, 4000K, C Input Power Designator	4 type MDA LEDs	XSPWAx3FC- U_RESTL-2014- -0018.IES 2013-0002.ies	Absolute	1.00	42.7
AT OVER	B' RHEADDOO	13 OR LOCA	XSPWAx3FC-U ATIONS	Cree XSPW Series Wallpack Luminaire, Type III Medium, 4000K, C Input Power Designator	4 type MDA LEDs	XSPWAx3FC- U_RESTL-2014- -0018.IES	Absolute	1.00	42.7
•	С	3	OSQ-A-xx-4ME-T- 30K-ULxxxxx w/OSQ-BLSLF CONFIGURED FROM OSQ-A-xx- 4ME-U-57K- ULxxxxx w/OSQ- BLSLF	Cree OSQ Series Area Luminaire, Type IV Medium w/ Backlight Shield, T Input Power Designator, 3000K CONFIGURED FROM Cree OSQ Series Area Luminaire, Type IV Medium w/ Backlight Shield, U Input Power Designator	CONFIGURED FROM MDA	OSQ-A-XX- 4ME-T-30K- ULXXXXX W_OSQ- BLSLF_CONFI GURED.ies	Absolute	1.00	166
	D	3	OSQ-A-xx-4ME-U- 30K-ULxxxxx CONFIGURED FROM OSQ-A-xx- 4ME-U-30K- ULxxxxx	Cree OSQ Series Area Luminaire, Type IV Medium, T Input Power Designator, 3000K CONFIGURED FROM Cree OSQ Series Area Luminaire, Type IV Medium, U Input Power Designator, 3000K	CONFIGURED FROM MDA	OSQ-A-XX- 4ME-U-30K- ULXXXXX_CON FIGURED.ies	Absolute	1.00	860
•	E	1	OSQ-A-xx-4ME-T- 30K-ULxxxxx CONFIGURED FROM OSQ-A-xx- 4ME-U-40K- ULxxxxx	Cree OSQ Series Area Luminaire, Type Iv Medium, T Input Power Designator, 3000K CONFIGURED FROM Cree OSQ Series Area Luminaire, Type Iv Medium, U Input Power Designator, 4000K	CONFIGURED FROM MDA	OSQ-A-XX- 4ME-T-30K- ULXXXXX_CON FIGURED.ies	Absolute	1.00	332
	F	1	OSQ-A-xx-4ME-T- 30K-ULxxxxx CONFIGURED FROM OSQ-A-xx- 4ME-U-30K- ULxxxxx	Cree OSQ Series Area Luminaire, Type Iv Medium, T Input Power Designator, 3000K CONFIGURED FROM Cree OSQ Series Area Luminaire, Type Iv Medium, U Input Power Designator, 3000K	CONFIGURED FROM MDA	OSQ-A-XX- 4ME-T-30K- ULXXXXX_CON FIGURED.ies	Absolute	1.00	498
â.	G	3	OSQ-A-xx-4ME-T- 30K-ULxxxxx CONFIGURED FROM OSQ-A-xx- 4ME-U-40K- ULxxxxx	Cree OSQ Series Area Luminaire, Type Iv Medium, T Input Power Designator, 3000K CONFIGURED FROM Cree OSQ Series Area Luminaire, Type Iv Medium, U Input Power Designator, 4000K	CONFIGURED FROM MDA	OSQ-A-XX- 4ME-T-30K- ULXXXXX_CON FIGURED.ies	Absolute	1.00	166
î.	Н	1	OSQ-A-xx-4ME-U- 30K-ULxxxxx CONFIGURED FROM OSQ-A-xx- 4ME-U-40K- ULxxxxx	Cree OSQ Series Area Luminaire, Type IV Medium, U Input Power Designator, 3000K CONFIGURED FROM Cree OSQ Series Area Luminaire, Type IV Medium, U Input Power Designator, 4000K	CONFIGURED FROM MDA	OSQ-A-XX- 4ME-U-30K- ULXXXXX_CON FIGURED.ies	Absolute	1.00	215
<u> </u>	J	1	OSQ-A-xx-4ME-U- 30K-ULxxxxx CONFIGURED FROM OSQ-A-xx- 4ME-U-40K- ULxxxxx	Cree OSQ Series Area Luminaire, Type IV Medium, U Input Power Designator, 3000K CONFIGURED FROM Cree OSQ Series Area Luminaire, Type IV Medium, U Input Power Designator, 4000K	CONFIGURED FROM MDA	OSQ-A-XX- 4ME-U-30K- ULXXXXX_CON FIGURED.ies	Absolute	1.00	430

1.8 fc

20.0 fc

0.0 fc

LANDSCAPE ]

**Landscape Consulting** & Master Planning Design Sevices

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Project:

WOLTER, INC.

1768 W. Mathew Drive De Pere, WI

Issuance and Revisions:

09/18/23

10/06/23

Date	Number	Description
08/19/23		Client Review Submittal
08/22/23		Plan Commissio Submittal

Revisions Based on Staff Review

on Site and Building Changes

Revisions Based

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<u>Sheet Title:</u>

PROPOSED PARTIAL PHOTOMETRIC LIGHT LEVELS CALCULATIONS PLAN - EASTERN HALF AND LIGHT FIXTURE TABLE

Date of Drawing:	10/06/23
Scale:	1" = 30'-0"
Drawn By:	MCD
Job Number:	L23-053

Sheet Number:

Avg/Min

N/A

Max/Min

N/A

PROPOSED PARTIAL PHOTOMETRIC LIGHT LEVELS CALCULATIONS PLAN - EASTERN HALF

\$\frac{1}{1.4} \frac{1.7}{1.8} \frac{1.8}{2.5} \frac{1.4}{2.9} \frac{1}{2.2} \frac{1}{2.4} \frac{1.6}{2.6} \frac{13}{3.6} \frac{1.6}{3.3} \frac{11.8}{11.8} \frac{11.0}{11.8} \frac{11.0}{11.8}

7.1/0.4/0.2 0.2 0.2 0.2 0.2 0.2 0.1 0.1 0.1 0.1

\*\*D.1 \*\*D.0 \*\*D.0

**3** 7.3 5.6 /3.2 **3** 9 1.7 **10** 7 0.5 0/3

4.6 /1.9 / 0.8 /0.5 D.5 0.6 0.9 1.5 1.1 1.0 1.1 0.0 0.8 10.7 10.3 0.2 0.2 0.2 0.1 0.1

3.7 3.3 4.0 3.0 /1.9 / 0.8 0.4 <del>0.3</del> 0.3 0.3 0.3 0.3 0.2 0.2 0.2 0.2 0.1 0.1 0.1 0.1 0.0 0.0

/1.5 <del>1.9 2</del>.0 2.2 3.8 3.9 /1.9 1.8 \1.8 \1.7 \2.1 2.4 3.9 7 8.2 8.2 8.2 6.4 54.4 )

▶2.7 2.5 3.4 4.0 5/8 3\1 (1\7 1\.3 1\1.1

SCALE: 1" = 30'-0"

0.1 0.1 0.1 0.1 0.2 0.2 0.2 0.2 0.1 0.1 0.1 0.1 0.1 0.2 0.5 1.5 2.8 3. 5.9 0.2 0.0

0.1 0.1 0.1 0.1 0.1 0.1 0.1 0.2 0.2 0.3 0.3 0.3 0.2 0.1 0.1 02 0.5 2.2 5.2

0.0 0.1 0.1 0.1 0.1 0.1 0.1 0.2 0.2 0.2 0.2 0.3 0.3 0.3 0.3 0.3 0.3 0.3 0.3 0.3 0.5 1.4 3.3 38 0

0.1 0.1 0.1 0.1 0.1 0.2 0.2 0.3 0.3 0.3 0.3 0.3 0.5 0.5 0.5 0.5 0.4 0/3 0.5 1/4 4.1 5.5 4 0.1 0.1 0.1 0.2 0.2 0.3 0.4 0.4 0.5 6.3 0.5 0.5 0.6 0.7 0.7 0.6 0.6 0.5 0.5 0.5 5.6 5.2 0.1 0.1 0.2 0.2 0.3 0.4 0.5 0.7 0.8 0.9 0.9 0.9 1.0 1.0 0.9 0.8 0.8 0.8 \0.7 1.2 3.1 7.5 9pg 0.2 0.2 0.3 0.4 0.5 0.6 0.9 1.2 1.5 1.7 1.6 1.6 1.8 1.6 1.1 0.9 0.9 7.0 1.1 1.2 2.8 7.9 12.8 1 0.2 10.3 10.3 10.4 10.6 10.8 1.0 1.5 22.2 2.7 2.9 2.8 3.2 3.8 2.3 1.4 4.0 0.9 1.1 1.4 7/8 2.8 16.6 13.9 15. 0.2 \( 0.3 \) \( \begin{pmatrix} 0.5 \) \( 0.6 \) \\ \\ \begin{pmatrix} 1.3 \\ \dagger 1.3 \\ \dagger 1.8 \\ \dagger 2.4 \\ \dagger 3.3 \\ \dagger 4.4 \\ \dagger 5.3 \\ \dagger 5.2 \\ \dagger 6.2 \\ \dagger 6.0 \\ \dagger 3.1 \\ \dagger 1.8 \\ \dagger 1.3 \\ \dagger 1.0 \\ \dagger 1.1 \\ \dagger 1.6 \\ \dagger 2.4 \\ \dagger 3.3 \\ \dagger 5.6 \\ \dagger 11.5 \\ \dagger 14.1 \\ \dagger 1.2 \\ \dagger 1.3 \\d 0.7 1.2 2.4 3.7 4.5 5.7 8.9 11.4 11.6 11.7 7.7 53.9 2.6 1.8 1.3 1.3 1,6 2.6 14.2 6.7 10.7 13.1 0.2 10.4 10.4 10.6 11.2 12.4 15.0 18.3 11.4 13.6 14.7 14.5 13.2 10.7 15.5 13.3 12.3 1.7 1.6 1/2.0 13.0 1/5.2 18.8 10.7 1/2.7 1 0.2 0.2 10.4 0.6 1.1 12.1 4.1 8.6 13.0 15.2 17.9 19.0 15.4 14.0 7.8 4.0 2.8 1.9 1.8 2.2 3.3 5.4 6.9 9.9 12.8 11.8 0.7 7.2 2.2 38 7.9 13.8 16.6 10.9 20.0 16.9 14.2 8.6 4.3 2.8 2.0 19 2.4 3.5 4.8 6.6 8.6 11.2 12.4 0.7 1.2 12.2 3.6 7.4 13.9 15.1 19.2 18.3 16.0 13.3 9.3 4.6 2.7 2.0 1/29 2.6 4.0 4/9 5.2 6.2 9.7 13.6 10 0.2 0.25 0.3 \0.5 0.9 0.5 \\ \0.5 \\ \0.7 \\ \0

0.1 0.1 0.2 0.3 0.4 0.6 0.9 1.1 1.3 1.6 2.0 2.8 3.6 4.1 4.3 4.6 5.5 4.2 2.3 1.4 1.0 0.8 0.7 0.6 0.7 1.8 5.5 9.7 9 0.2 \0.3 \0.4 \0.6 \0.9 \dagged 1.2 \dagged 1.7 \dagged 2.3 \dagged 3.0 \dagged 3.8 \dagged 5.4 \dagged 7.5 \dagged 8.3 \dagged 9.1 \dagged 5.1 \dagged 2.8 \dagged 3.9 \dagged 1.3 \dagged 0.9 \dagged 0.7 \dagged 0.6 \dagged 0.7 \dagged 1.4 \dagged 3.6 \dagged 8.2 \dagged 6.1 \$\\daggregartarrow\daggregarta - 0.1 0.1 | 0.2 | 0.2 | 0.3 | 0.4 | 0.6 | 0.9 | 1.6 | 2.8 | 5.2 | 11.3 | 14.2 | 18.6 | 20.0 | 18.7 | 14.6 | 12.8 | 6.25 | 3.4 | 2.1 | 1.3 | 0.9 | 0.7 | 0.λ | 0.8 | 1.8 | 4.45 | 5.5 | 4.0

\$\\\[ \tau\_.5 \\ \dagger 0.8 \\ \dagger 1.3 \\ \dagger 2.4 \\ \dagger 4.2 \\ \dagger 3.6 \\ \dagger 3.3 \\ \dagger 3.5 \\ \dagger 3.4 \\ \dagger 3.2 \\ \dagger 2.6 \\ \dagger 2.1 \\ \dagger 2.1 \\ \dagger 2.1 \\ \dagger 1.9 \\ \dagger 1.9 \\ \dagger 1.2 \\\dagger 1.2 \\\da

0.2 0.2 | 10.3 | 10.7 | 1.1 | 1.7 | 3.1 | 5.9 | 6.8 | 5.9 | 6.0 | 5.3 | 4.1 | 3.2 | 2.8 | 2.5 | 2.4 | 2.3 | 1.9 | 1.6 | 1.6 | 1.6 | 1.7 | 1.8 | 2.4 | 2.4 |

± 0.1 0.1 p.2 0.2\ p.3 | p.4 \ 0.5 v\9 1.5 ±.7 t\3 8.7 t\3.8 t\5.4 t\7.2 t\5.5 t\3.8 t\2.6 7.7 \ 4.0 ±.3 t\5.5 t\3.8 t\5.6 t\5.7 \ 4.0 ±.3 t\5.6 t\5.7 t\5.0 t\9 1.5 t\7.2 t\7.9 t\5.8 t\5.6 t\5.7 t\7.9 t\ \$\bar{0}.4 \disp.5 \di \$ \$\dagger 0.3 \quad \tau.0 \quad \tau.0 \quad \tau.0 \quad \tau.5 \quad \tau.3 \quad \tau.1 \quad \tau.5 \quad \tau.6 \quad \tau.2 \quad \tau.6 \quad \tau.2 \quad \tau.3 \quad \tau.1 \quad \tau.3 \quad \tau.4 \quad \tau.4 \quad \tau.3 \quad \tau.4 \quad \quad \tau.4 \quad \quad \quad \tau.4 \quad \quad

0.1 0.1 1.1 1.5 0.2 0.2 0.3 0.4 0.5 0.8 1.1 1.9 3.4 5.7 4.9 1.3 4.2 3.8 3.3 2.7 2.5 2.3 2.3 2.5 2.7 3.1 3.5 4.8 5.6 5.5 6.6 7.5 

0.1 0.1 p.1 0.1 p.2 p.2 p.2 v.2 0.3 0.4 p.5 0.7 0.8 v.1 v.4 v.1 v.4 v.1 v.5 6.6 v.1.2 v.4 v.4.7 v.5.0 v.4.2 v.4.0 v.1 v.8 v.7 70.2 10.2 70.3 10.3 10.4 70.5 10.6 1/19 11.3 11./7 12.4 13.4 15.9 12.2 14.1x 18.18 13.9 14.8 12.0 15.9 \13.5 12.5 11.7 11.1 10.7 10.55 10.4 10.4 10.8 10.7 13.8 10.5 17.3 17.3 □ 5.1 □ 5.1 □ 5.2 □ 5.2 □ 5.2 □ 5.2 □ 5.3 □ 5.4 □ 5.5 □ 5.7 □ 5.5 □ 5.7 □ 5.5 □ 5.9 □ 5.5 □ 5.3 □ 5.6 □ 5.1 □ 5.6 □ 5.0 □ 6.3 □ 6.4 □ 6.4 □ 6.3 □ 6.4 . \$\dagged \$\dagged

0.1 0.1 \display 0.2 \display 0.2 \display 0.2 \display 0.3 \display 0.3 \display 0.4 \display 0.5 \display 0.7 \display 0.1 \display 0.5 \display 0.3 \display 0.4 \display 0.5 \display 0.7 \display 0.1 \display 0.2 \display 0 \$\frac{1}{2}\$\$\frac{1}{3}\$\$\frac{1}{0}\$.4 \$\frac{1}{0}\$.5 \$\frac{1}{0}\$.7 \$\frac{1}{0}\$.9 \$\frac{1}{1}\$.3 \$\frac{1}{2}\$.4 \$\frac{1}{3}\$.4 \$\frac{1}{3}\$.4 \$\frac{1}{3}\$.4 \$\frac{1}{3}\$.9 \$\frac{1}{2}\$.4 \$\frac{1}{1}\$.8 \$\frac{1}{1}\$.3 \$\frac{1}{0}\$.9 \$\frac{1}{0}\$.2 \$\fr 0.1 0.2 \$\dagger{0.2} \dagger{0.2} \dagger{0.2} \dagger{0.3} \dagger{0.3} \dagger{0.3} \dagger{0.5} \dagger{0. \$\frac{1}{1.0}\$\$\frac{1}{1.0}\$\$\frac{1}{1.0}\$\$\frac{1}{1.0}\$\$\frac{1}{1.0}\$\$\frac{1}{2.4}\$\$\frac{1}{3.4}\$\$\frac{1}{4.4}\$\$\frac{1}{4.7}\$\$\frac{1}{4.0}\$\$\frac{1}{3.3}\$\$\frac{1}{3.0}\$\$\frac{1}{2.5}\$\$\frac{1}{2.0}\$\$\frac{1}{1.9}\$\$\frac{1}{2.0}\$\$\frac{1}{1.9}\$\$\frac{1}{1.0}\$\$\frac{1}{0.7}\$\$\frac{1}{0.4}\$\$\frac{1}{0.4}\$\$\frac{1}{0.2}\$\$\frac{1}{0.1}\$\$\frac 

70.4 \partial 5 \partial 8 \partial 1.1 \quad 1.5 \quad \frac{1}{2}.1 \quad 3.0 \quad \frac{1}{5}.0 \quad 6.9 \quad 7.5 \quad 7.8 \quad 6.8 \quad 6.0 \quad 3.7 \quad 2.7 \quad \frac{1}{2}.0 \quad 1.4 1. \display 1.3 \display \dinfty \dinfty \display \display \display \display \display \display \display \display \displa tl.1 tl.2 to.3 to.5 to.8 to.4 \$2.2 to.2 to.0 to.0 to.0 to.0 to.6 to.4 to.3 to.2 to.2 to.1 to.1 to.1 to.1 to.0 to.0

0.2 0.4 0.5 0.7 0.9 1.0 1.0 1.0 0.8 0.8 0.4 0.30.25.2 0.2 0.1 0.1 0.1 0.1 0.1 0.1 0.0 0.1 0.1 0.2 0.2 0.3 0.4 0.4 0.3 0.2 0.2 0.1 0.1 0.1 0.1 0.1 0.1 0.0

PROPOSED PARTIAL PHOTOMETRIC LIGHT LEVELS CALCULATIONS PLAN - EASTERN HALF

0.0 0.0 0.0 0.0 SCALE: 1" = 30'-0"

Description Calc Zone #1

LUMINAIRE SCHEDULE

		_	UL-xx-40K	Lens, 122W, 4000K	4000K color temperature.	F-A-UL-xx- 40K_RESTL- 2013-0002.ies	,		
AT MAN DO	B OOR LOC	8 ATIONS	XSPWAx3FC-U	Cree XSPW Series Wallpack Luminaire, Type III Medium, 4000K, C Input Power Designator	4 type MDA LEDs	XSPWAx3FC- U_RESTL-2014- -0018.IES 2013-0002.ies	Absolute	1.00	42.7
AT OVERH	B'	13 DR LOCA	XSPWAx3FC-U	Cree XSPW Series Wallpack Luminaire, Type III Medium, 4000K, C Input Power Designator	4 type MDA LEDs	XSPWAx3FC- U_RESTL-2014- -0018.IES	Absolute	1.00	42.7
	C	3	OSQ-A-xx-4ME-T- 30K-ULxxxxx w/OSQ-BLSLF CONFIGURED FROM OSQ-A-xx- 4ME-U-57K- ULxxxxx w/OSQ- BLSLF	Cree OSQ Series Area Luminaire, Type IV Medium w/ Backlight Shield, T Input Power Designator, 3000K CONFIGURED FROM Cree OSQ Series Area Luminaire, Type IV Medium w/ Backlight Shield, U Input Power Designator	CONFIGURED FROM MDA	OSQ-A-XX- 4ME-T-30K- ULXXXXX W_OSQ- BLSLF_CONFI GURED.ies	Absolute	1.00	166
	D	3	OSQ-A-xx-4ME-U- 30K-ULxxxxx CONFIGURED FROM OSQ-A-xx- 4ME-U-30K- ULxxxxx	Cree OSQ Series Area Luminaire, Type IV Medium, T Input Power Designator, 3000K CONFIGURED FROM Cree OSQ Series Area Luminaire, Type IV Medium, U Input Power Designator, 3000K	CONFIGURED FROM MDA	OSQ-A-XX- 4ME-U-30K- ULXXXXX_CON FIGURED.ies	Absolute	1.00	860
•	Е	1	OSQ-A-xx-4ME-T- 30K-ULxxxxx CONFIGURED FROM OSQ-A-xx- 4ME-U-40K- ULxxxxx	Cree OSQ Series Area Luminaire, Type Iv Medium, T Input Power Designator, 3000K CONFIGURED FROM Cree OSQ Series Area Luminaire, Type Iv Medium, U Input Power Designator, 4000K	CONFIGURED FROM MDA	OSQ-A-XX- 4ME-T-30K- ULXXXXX_CON FIGURED.ies	Absolute	1.00	332
	F	1	OSQ-A-xx-4ME-T- 30K-ULxxxxx CONFIGURED FROM OSQ-A-xx- 4ME-U-30K- ULxxxxx	Cree OSQ Series Area Luminaire, Type Iv Medium, T Input Power Designator, 3000K CONFIGURED FROM Cree OSQ Series Area Luminaire, Type Iv Medium, U Input Power Designator, 3000K	CONFIGURED FROM MDA	OSQ-A-XX- 4ME-T-30K- ULXXXXX_CON FIGURED.ies	Absolute	1.00	498
<u>.</u>	G	3	OSQ-A-xx-4ME-T- 30K-ULxxxxx CONFIGURED FROM OSQ-A-xx- 4ME-U-40K- ULxxxxx	Cree OSQ Series Area Luminaire, Type Iv Medium, T Input Power Designator, 3000K CONFIGURED FROM Cree OSQ Series Area Luminaire, Type Iv Medium, U Input Power Designator, 4000K	CONFIGURED FROM MDA	OSQ-A-XX- 4ME-T-30K- ULXXXXX_CON FIGURED.ies	Absolute	1.00	166
<u></u>	Н	1	OSQ-A-xx-4ME-U- 30K-ULxxxxx CONFIGURED FROM OSQ-A-xx- 4ME-U-40K- ULxxxxx	Cree OSQ Series Area Luminaire, Type IV Medium, U Input Power Designator, 3000K CONFIGURED FROM Cree OSQ Series Area Luminaire, Type IV Medium, U Input Power Designator, 4000K	CONFIGURED FROM MDA	OSQ-A-XX- 4ME-U-30K- ULXXXXX_CON FIGURED.ies	Absolute	1.00	215
<u>-</u>	J	1	OSQ-A-xx-4ME-U- 30K-ULxxxxx CONFIGURED FROM OSQ-A-xx- 4ME-U-40K- ULxxxxx	Cree OSQ Series Area Luminaire, Type IV Medium, U Input Power Designator, 3000K CONFIGURED FROM Cree OSQ Series Area Luminaire, Type IV Medium, U Input Power Designator, 4000K	CONFIGURED FROM MDA	OSQ-A-XX- 4ME-U-30K- ULXXXXX_CON FIGURED.ies	Absolute	1.00	430
STATIS	TICS								
escription			Symbol A	vg Max	Min Max/I	Min Avg/Miı	1		

72 type XTE AWT LEDs

on white square PCB.

CPY250-A-xx- Absolute 1.00

Cree CPY250 Canopy /

24 4.2 5.1 6.0 5.1 5.2 2.8

0.5 0.6 1.2 2.9 5.0 5.7 6.3 7.0 5.4 4.0

18 3 45 5.3 5.8 3.9 3.4 1,4 0,8 0.4 0.4 0.4

3.7 3.3 4.0 3.0 /1.9 / 0.8 / 0.4 / 0.3 0.3 0.3

- FIXTURE "C" (3) IS A NEW POLE LOCATION W/ NEW POLE MOUNTED FIXTURES (SINGLE HEAD AND TENONS W/ BACKLIGHT/HOUSE SIDE SHIELD). FIXTURES ARE TO BE INSTALLED ON A NEW 2'-6" TALL REINFORCED POURED CONCRETE FOUNDATION AND NEW 18'-0" DARK BRONZE POLE.
- FIXTURE "F" (1) IS A NEW POLE LOCATION W/ NEW POLE MOUNTED FIXTURES (TRIPLE HEAD AND TENONS). FIXTURES ARE TO BE INSTALLED ON A NEW 2'-6" TALL REINFORCED POURED CONCRETE FOUNDATION AND NEW 18'-0" DARK BRONZE POLE.
- FIXTURE "D" (3) IS A NEW POLE LOCATION W/ NEW POLE MOUNTED FIXTURES (QUAD HEAD, TENON). FIXTURES ARE TO BE INSTALLED ON A NEW 4'-0" TALL REINFORCED POURED CONCRETE FOUNDATION AND NEW 20'-0" DARK BRONZE POLE. FIXTURE "E" (1) IS A NEW POLE LOCATION W/ NEW POLE MOUNTED FIXTURES (TWIN HEAD AND TENONS). FIXTURES ARE TO BE INSTALLED ON A NEW 2'-6" TALL REINFORCED
- POURED CONCRETE FOUNDATION AND NEW 18'-0" DARK BRONZE POLE. FIXTURE "G" (3) IS A NEW POLE LOCATION W/ NEW POLE MOUNTED FIXTURES (SINGLE FORWARD THROW HEAD AND TENONS). FIXTURES ARE TO BE INSTALLED ON A NEW
- 2'-6" TALL REINFORCED POURED CONCRETE FOUNDATION AND NEW 18'-0" DARK BRONZE POLE. FIXTURE "H" (1) IS A NEW POLE LOCATION W/ NEW POLE MOUNTED FIXTURES (SINGLE FORWARD THROW HEAD AND TENONS). FIXTURES ARE TO BE INSTALLED ON A NEW 4'-0"
- TALL REINFORCED POURED CONCRETE FOUNDATION AND NEW 20'-0" DARK BRONZE POLE. PROTECT WITH 6" CONCRETE FILLED BOLLARDS AS REQUIRED. FIXTURE "J" (2) IS A NEW POLE LOCATION W/ NEW POLE MOUNTED FIXTURES (TWIN @ 90 DEGREE INSTALL, FORWARD THROW HEAD AND TENONS ). FIXTURES ARE TO BE INSTALLED ON A NEW 4'-0" TALL REINFORCED POURED CONCRETE FOUNDATION AND NEW 20'-0" DARK BRONZE POLE . PROTECT WITH 6" CONCRETE FILLED BOLLARDS AS
- ALL PROPOSED FIXTURE HEADS AND FLOOD LIGHTS ARE TO BE DARK-SKY COMPLIANT AND HAVE HARDWARE WITH IESNA FULL CUTOFF HOUSE SIDE SHIELDING WHERE

9. FOR CALCULATION PURPOSED MAN DOOR FIXTURES PLACED AT 10'-0" AFF AS SHOWN ON PLAN. OVERHEAD DOOR FIXTURES PLACED AT 15'-0" AFF. REFER TO ARCHITECTURAL DRAWINGS FOR EXACT MOUNTING HEIGHTS OF ALL BUILDING MOUNTED FIXTURES. COORDINATE WITH ORDINANCE 14-095 OUTDOOR LIGHTING(D) MOUNTED FIXTURE HEIGHT: PARKING LOT LIGHTING MUST BE MOUNTED NO HIGHER THAN 30 FEET OF AVERAGE GRADE AT THE BASE. ALL OTHER ON-SITE LIGHTS MUST BE MOUNTED NO HIGHER THAN 15 FEET ABOVE GRADE DIRECTLY BELOW THE FIXTURE.

0.0 fc

N/A

N/A

10. REFER TO ARCHITECTURAL DRAWINGS FOR EXACT MOUNTING HEIGHTS OF ALL BUILDING MOUNTED FIXTURES.

20.0 fc

11. CALCULATION GRID IS SHOWN IN A 5'-0" X 5'-0" SPACING AT A HEIGHT OF 0'-0"

1.8 fc

- 12. INSTALLATION CONTRACTOR TO REFER TO ELECTRICAL PLANS FOR CONDUIT ROUTING OF LIGHT POLES AND SIGNAGE LIGHTING CONTROL AND WIRING.
- 13. ALL NEW CONCRETE LIGHT POLE BASES ARE TO HAVE ALL EXPOSED FORM MARKS REMOVED, GROUND FLUSH AND THE SURFACE IS TO BE PROPERLY PREPARED TO RECEIVE A HAND TROWELED, MASONRY SKIM COAT OF APPROPRIATE THICKNESS TO ACHIEVE A DURABLE SURFACE AND LONG LASTING AESTHETIC.
- 14. ALL NEW PROPOSED AREA LIGHT POLES SHALL BE LOCATED 3-0" FROM BACK OF CURB TO THE EDGE OR FACE OF THE REINFORCED LIGHT POLE BASE, UNLESS NOTED
- 15. CONTRACTOR TO REFER TO REINFORCED LIGHT POLE BASE SECTION AND DETAIL FOR FURTHER INFORMATION.

THIS LIGHTING PLAN REPRESENTS ILLUMINATION LEVELS ARE CALCULATED VALUES INCLUDE DIRECT AND INTER-REFLECTED COMPONENT AND ILLUMINATION LEVELS CALCULATED FROM LABORATORY DATA TAKEN UNDER CONTROLLED CONDITIONS IN ACCORDANCE WITH THE ILLUMINATING ENGINEERING SOCIETY (IES) APPROVED METHODS. ACTUAL PERFORMANCE OF ANY MANUFACTURER'S LUMINAIRES MAY VARY DUE TO CHANGES IN ELECTRICAL VOLTAGE, TOLERANCE IN LAMPS/LED'S AND OTHER MAY VARY DUE TO CHANGES IN ELECTRICAL VOLTAGE, TOLERANCE IN LAMPS/LED'S AND OTHER VARIABLE FIELD CONDITIONS. CALCULATIONS DO NOT INCLUDE OBSTRUCTIONS SUCH AS BUILDINGS CURBS, LANDSCAPING, OR ANY OTHER ARCHITECTURAL ELEMENTS UNLESS NOTED.



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WOLTER, INC.

1768 W. Mathew Drive De Pere, WI

Issuance and Revisions:

Date	Number	Description
08/19/23		Client Review Submittal
08/22/23		Plan Commission

09/18/23 on Site and Building Changes

10/06/23 Revisions Based on Staff Review

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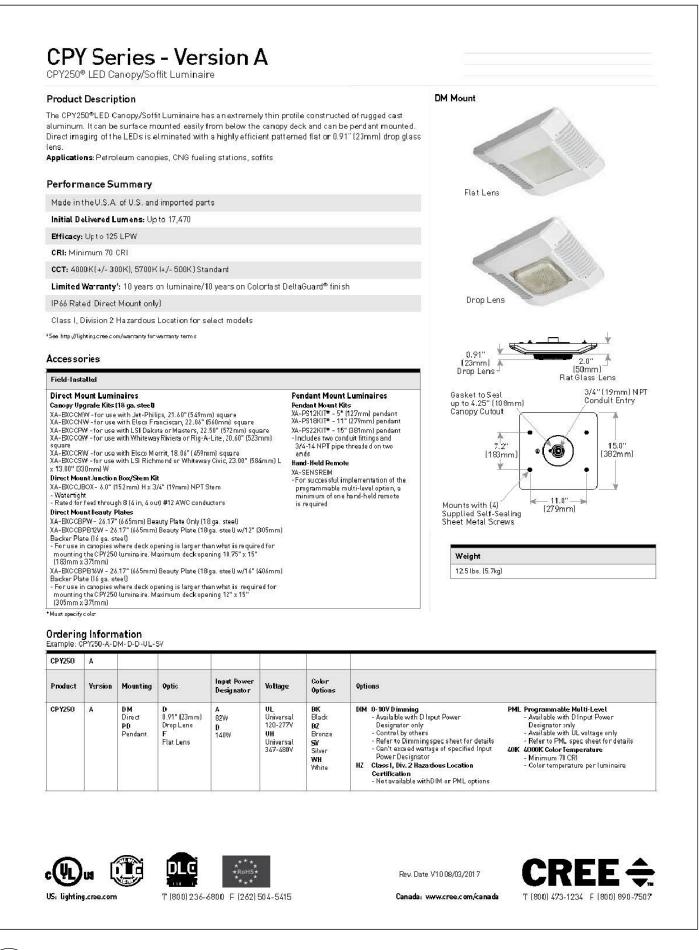
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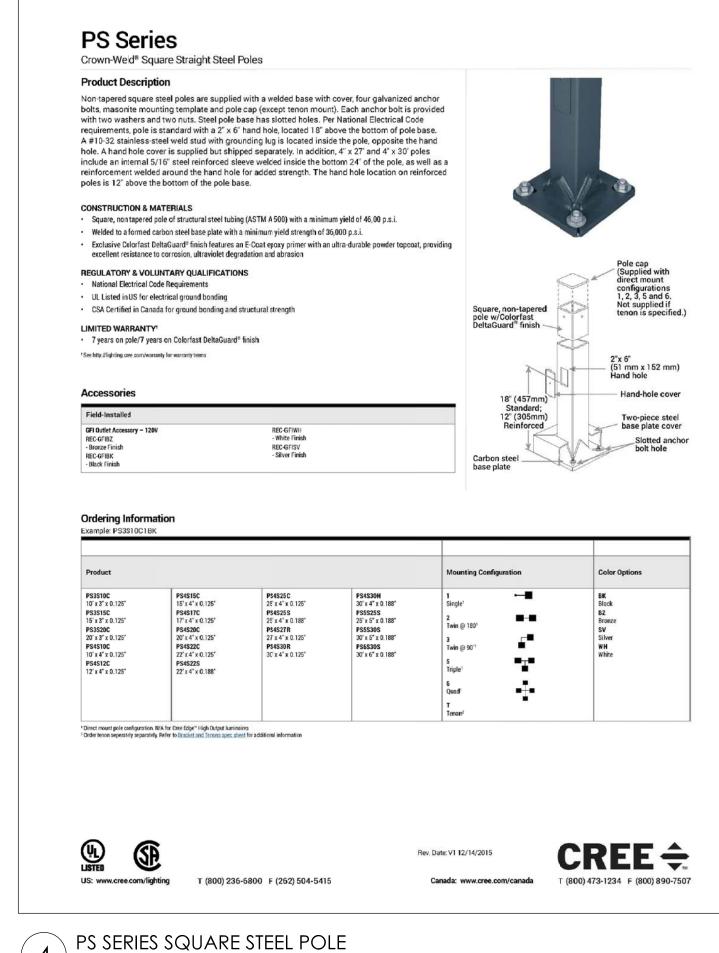
PROPOSED PARTIAL PHOTOMETRIC LIGHT LEVELS CALCULATIONS PLAN - WESTERN HALF AND LIGHT FIXTURE TABLE


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Scale:	1" = 30'-0"
Drawn By:	MCD
Job Number:	L23-053


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PB SERIES SQUARE STEEL POLE BRACKET

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Issuance and Revisions:

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09/18/23 **Revisions Based** on Site and

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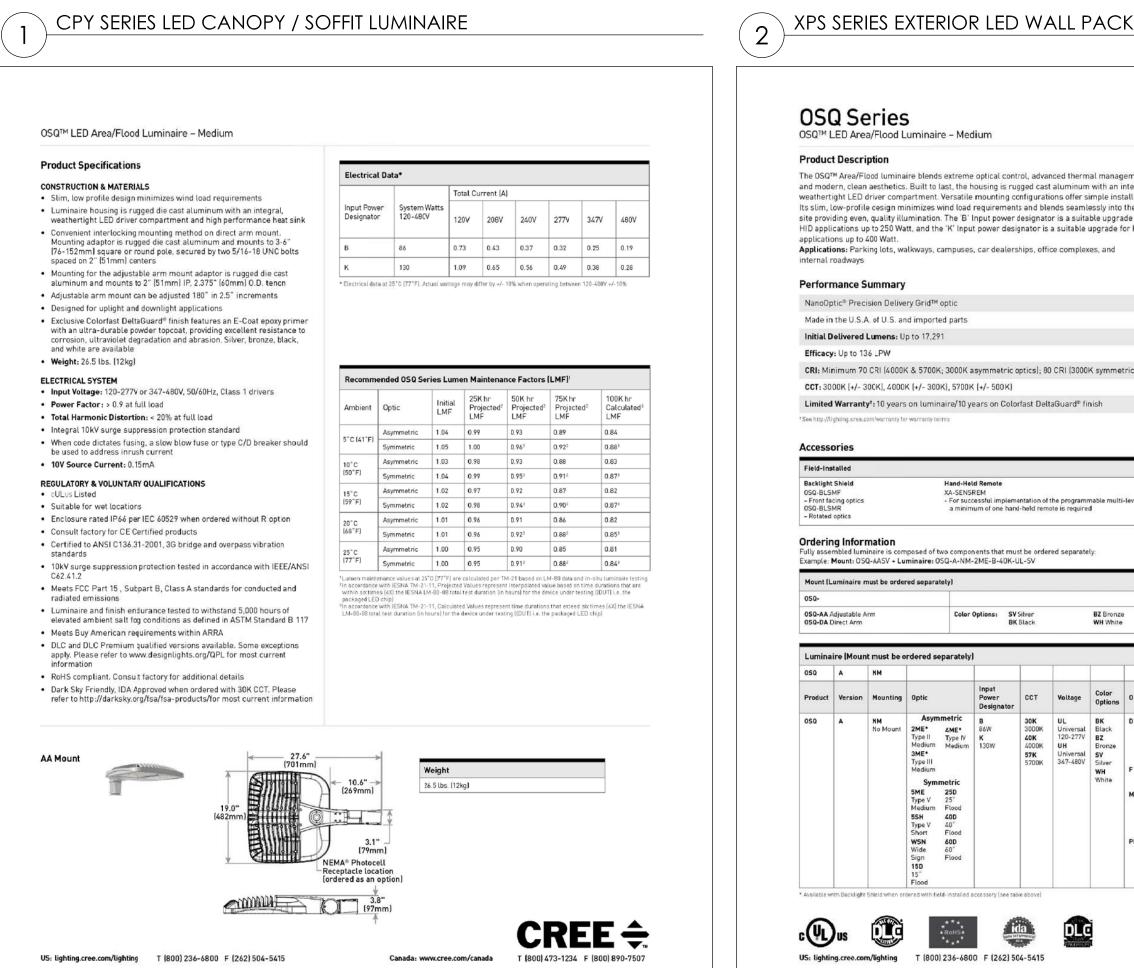
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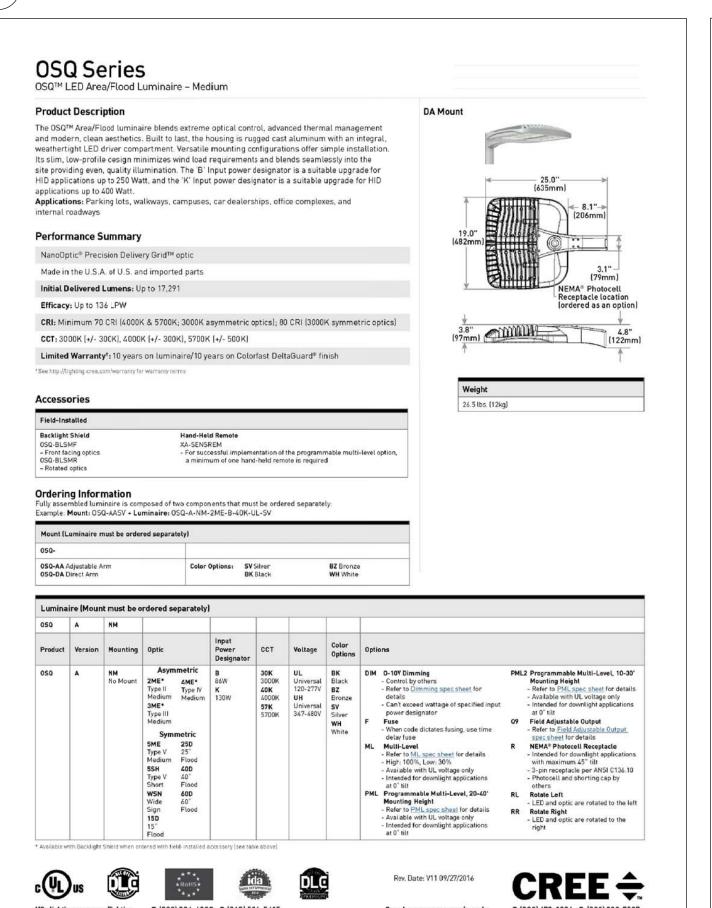
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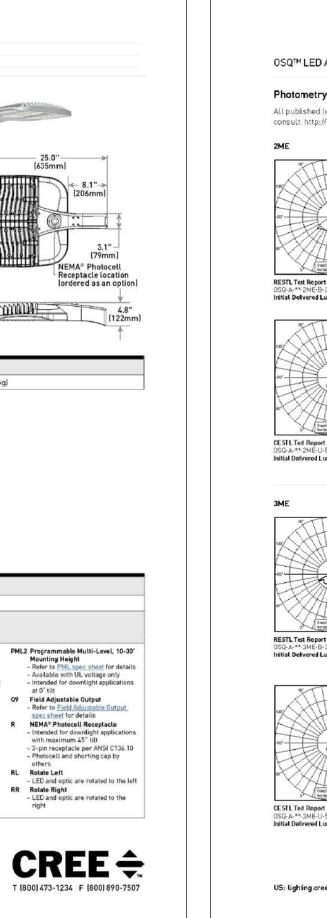
PROPOSED LIGHT FIXTURES

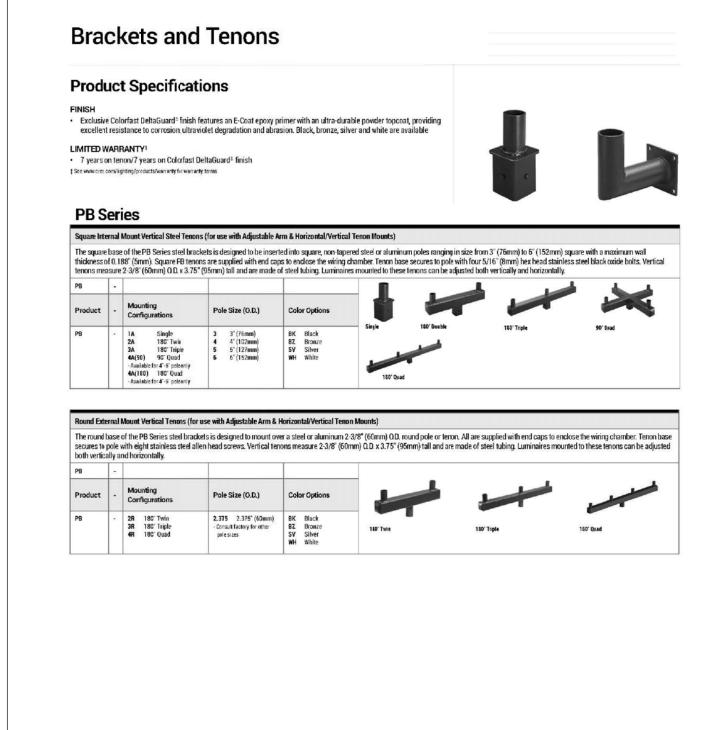
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Job Number:	L23-053

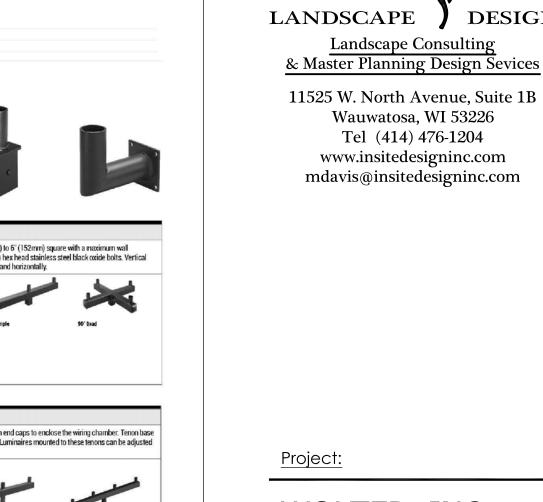


OSQ SERIES LED AREA/FLOOD





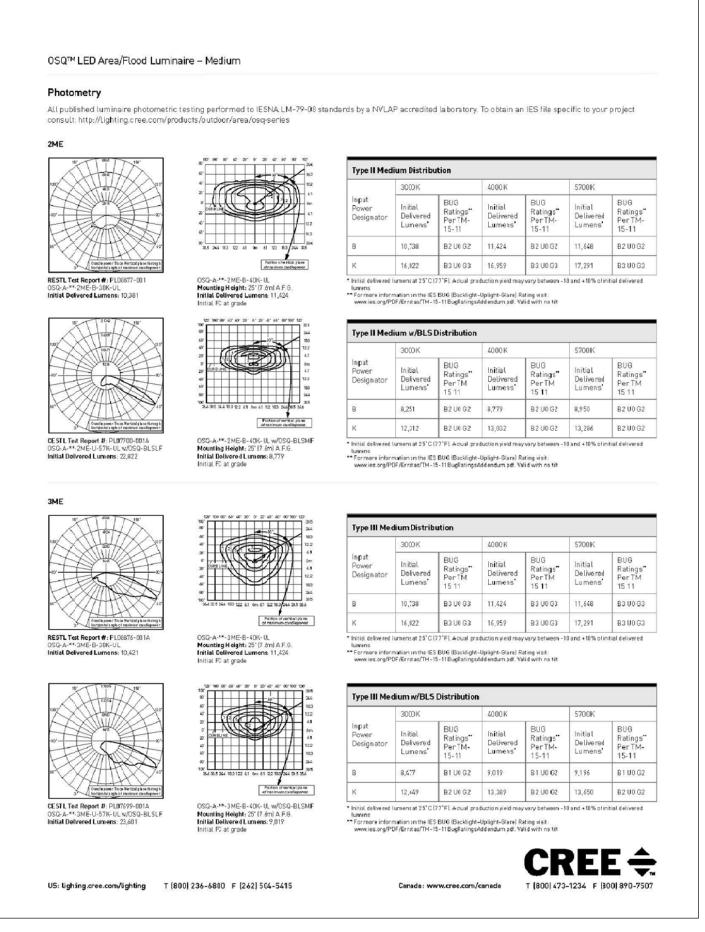

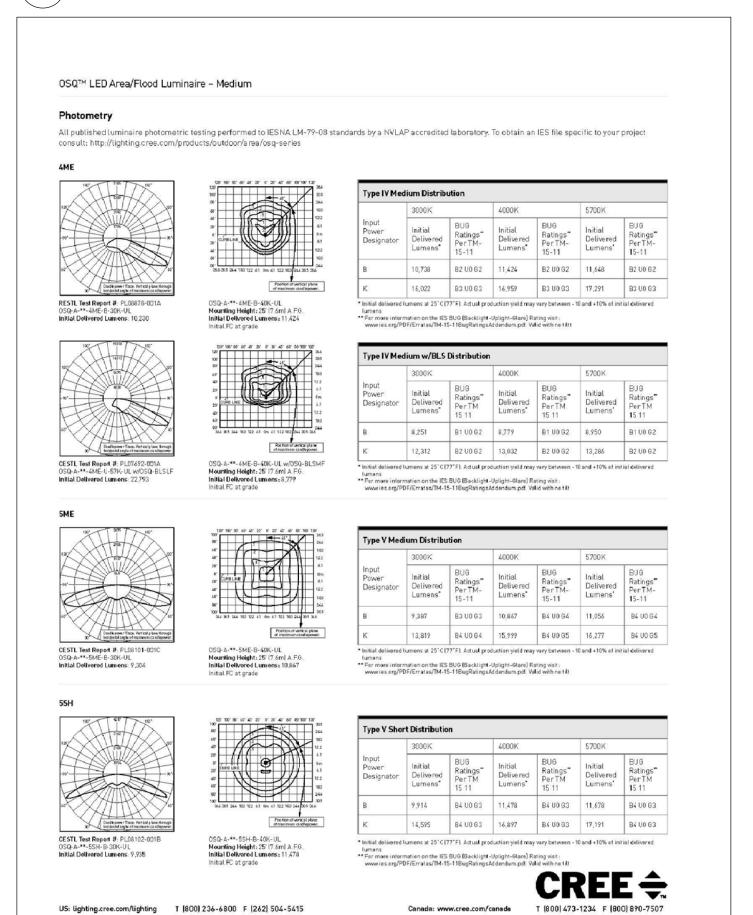

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